


WA-CLEC, LLC

MERCER ISLAND **SMALL CELL SOLUTION MIN 12**

CONSTRUCTION DRAWINGS

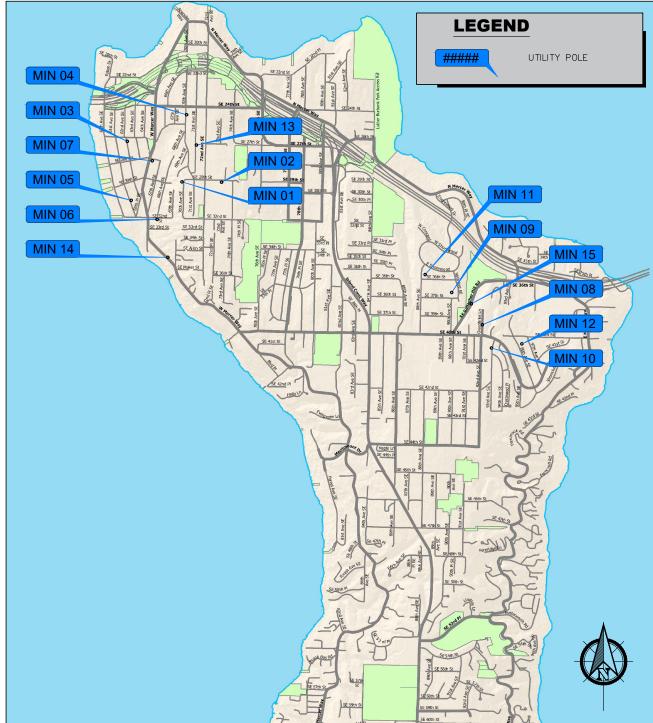

PROJECT INFORMATION

PROJECT NAME: MERCER ISLAND SMALL CELL SOLUTION

DESIGN TYPE: SMALL CELL SOLUTION MERCER ISLAND

AUTHORITY HAVING JURISDICTION (AHJ):

COUNTY:

KING COUNTY

STATE: WASHINGTON

UTILITY COMPANY: PUGET SOUND ENERGY

OCCUPANCY: N/A | UNMANNED COMMUNICATIONS FACILITY

CONSTRUCTION TYPE: FULLY SPRINKLED: NOT REQUIRED

A.D.A. COMPLIANCE: THIS FACILITY IS UNMANNED AND NOT INTENDED

GOVERNING CODES: INTERNATIONAL BUILDING CODE W/ AMEND. [2012]

WASHINGTON CITIES ELECTRICAL CODE [CURRENT]

TIA 222 | REVISION G. [2009]

CONTACT INFORMATION

CONSTR. MNGR:

WA-CLEC, LLC (CROWN CASTLE) WYCO FIELD SERVICES, LLC CONTACT: PHIL REAGAN CONTACT: VIC PETERSON PHONE: (425) 354-0043 PHONE: (253) 906-7727

EMAIL: philip.reagan@crowncastle.com

PROJECT MGR:

PSE FIELD INSPECTOR:

WA-CLEC, LLC (CROWN CASTLE) SURVEYOR T.B.D. CONTACT: T.B.D. PHONE: T.B.D.

ENGINEERING FIRM:

EMAIL: vpeterson@wycofs.com

SURVEYOR:

CONTACT: MARCUS HAILEY PHONE: (206) 336-7399 EMAIL: marcus.hailey@crowncastle.com EMAIL: T.B.D.

APPROVALS / SIGNATURES

PROJECT MANAGER: CITY REPRESENTATIVE: CROWN PROJECT MANAGER: COUNTY REPRESENTATIVE: CUSTOMER REPRESENTATIVE:

NODE INFORMATION MIN 12

NODE:

ADDRESS: 4030 96TH AVE SE

CITY, STATE, ZIP: MERCER ISLAND, WA 98040

POLE ID: 221234-165980

EXISTING POLE HEIGHT: 30'-0" PROPOSED POLE HEIGHT: 38'-6"

DRAWING INDEX

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CIVIL DETAILS

RF NOTES & DETAILS RF WIRING DIAGRAM

EQUIPMENT SPECIFICATIONS

GROUNDING PLAN & ELEVATION GROUNDING DETAILS

ELECTRICAL NOTES & ONE LINE DIAGRAM

CAUTION
FOREIGN UTILITY LOCATIONS ARE APPROXIMATE.
IT IS THE CONSTRUCTION CONTRACTOR'S
RESPONSIBILITY TO CONTACT THE LOCAL ONE CALL
AGENCY 48 HOURS PRIOR TO CONSTRUCTION FOR
EXACT UTILITY LOCATIONS AT: 1-800-424-5555 (or 811)





FIELD SERVICES

6390 E. 49th Avenue Commerce City, CO 80020 www.WYCOFS.com

Construction Drawings

02/07/17

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MERCER ISLAND SMALL CELL SOLUTION


4030 96TH AVE SE Mercer Island, WA 98040 Pole ID: 221234-165980

LATITUDE: 47.57374171 **LONGITUDE:** -122.2123403

. REPARED AND DESIGNED TO BE PLOTTED C "x17") OR (22"x34") PAPER. ALL SCALES

TITLE SHEET

MERCER ISLAND SMALL CELL SOLUTION

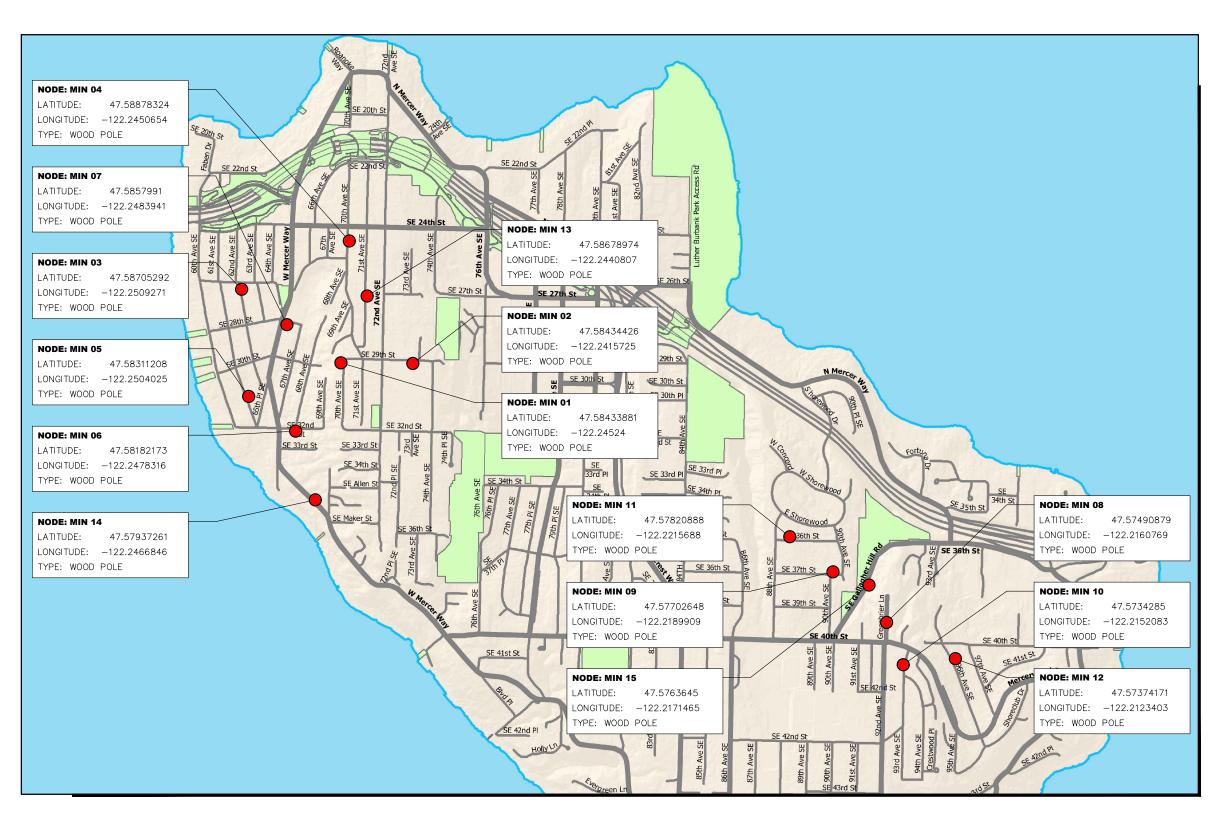





6390 E. 49th Avenue Commerce City, CO 80020 www.WYCOFS.com

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02/07/17

Construction Drawings

MERCER ISLAND SMALL CELL SOLUTION

MIN 12

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VICINITY MAP



#	POUNDS OR LBS.			
A	AMPERES (ELEC)			
A.B.	ANCHOR BOLT			
ABC	AGGREGATE BASE COURSE			
ACI	AMERICAN CONCRETE INSTITUTE			
AF	AMPERES FRAME (BREAKER RATIN (ELEC)			
A.F.F.	ABOVE FINISHED FLOOR			
A.F.G.	ABOVE FINISHED GRADE			
A.G.L.	ABOVE GROUND LEVEL			
AH	AMPERE HOURS (ELEC)			
AIA	AMERICAN INSTITUTE OF ARCHITECTS			
AIC	AMPS INTERRUPTING CAPACITY			
AISC	AMERICAN INSTITUTE OF STEEL CONSTRUCTION			
AITC	AMERICAN INSTITUTE OF TIMBER CONSTRUCTION			
AMSL	ABOVE MEAN SEA LEVEL			
ANSI	AMERICAN NATIONAL STANDARDS INSTITUTE			
A.P.L.	ABOVE PARAPET LEVEL			
AR	AUDIENCE RIGHT			
A.R.L.	ABOVE ROOF LEVEL			
ASCE	AMERICAN SOCIETY OF CIVIL ENGINEERS			
ASME	AMERICAN SOCIETY OF MECHANICA			
AT	AMPERES TRIP (BREAKER SETTING			
ATS	AUTOMATIC TRANSFER SWITCH			
AUX	AUXILIARY			
AWG	AMERICAN WIRE GAUGE			
AWS	AMERICAN WELDING SOCIETY			
AZ or AZ.	AZIMUTH			
BKR	BREAKER			
BPS	BOLTED PRESSURE SWITCH			
BTS	BASE TRANSCEIVER STATION			
BW	BUTT WELD			
<u> </u>	CONDUIT			
CB	CIRCUIT BREAKER			
CC or CROWN	CROWN CASTLE, INC.			
C.J.	CONTROL JOINT			
CKT	CIRCUIT			
CMU	CONCRETE MASONRY UNIT			
СТ	CURRENT TRANSFORMER			
DEMO	DEMOLITION			
DIM	DIMENSION			
DISC	DISCONNECT			
DL	DEAD LOAD			
DP	DISTRIBUTION PANEL			
DS	DOWNSTAGE			
DWG	DRAWING			

EA	EACH			
EC	ELECTRICAL CONTRACTOR			
E.F.	EACH FRAME			
E.G.	EQUIPMENT GROUND			
EGB	EXTERIOR GROUND BUS			
E.J.	EXPANSION JOINT			
ELEC	ELECTRICAL			
	EMERGENCY			
EM / EMERG	EMERGENCI			
EME	ELECTROMAGNETIC ENERGY			
EMT	ELECTRICAL METALLIC TUBING			
EO	ELECTRICALLY OPERATED			
E.S.	EACH SIDE			
E.W.	EACH WAY			
EXIST. / (E)	EXISTING			
EXT.	EXTERIOR			
XP	EXPLOSION PROOF			
FA	FIRE ALARM			
FAB.	FABRICATE			
FEMA	FEDERAL EMERGENCY MANAGEMENT AGENCY			
FDN	FOUNDATION			
FLA	FULL LOAD AMPS			
FLR	FLOOR			
FLUOR	FLUORESCENT			
F.O.M.	FACE OF MASONRY			
FU	FUSE			
FW	FILLET WELD			
FY	YIELD STRESS OF STEEL			
G	GROUNDING (ELEC)			
GA	GAGE OR GAUGE			
GALV	GALVANIZED			
GB	GRADE BREAK			
GEN	GENERATOR			
GRD	GRADE OR EXISTING GRADE			
GFCI	GROUND FAULT CIRCUIT INTERRUPTER			
G.S.N.	GENERAL STRUCTURAL NOTES			
НОА	HAND-OFF-AUTO (ELEC)			
HVAC	HEATING, VENTILATION AND AIR CONDITIONING EQUIP.			
HP	HORSEPOWER			
HV	HIGH VOLTAGE			
HV HZ	HIGH VOLTAGE HERTZ			
HZ	HERTZ			
HZ IBC	HERTZ INTERNATIONAL BUILDING CODE INTERNATIONAL CONFERENCE OF			
HZ IBC ICBO	HERTZ INTERNATIONAL BUILDING CODE INTERNATIONAL CONFERENCE OF BUILDING CODES			
HZ IBC ICBO	HERTZ INTERNATIONAL BUILDING CODE INTERNATIONAL CONFERENCE OF BUILDING CODES INTERNATIONAL CODE COUNCIL INSTITUTE OF ELECTRICAL AND			

IPGB	INTERNAL PERIMETER GROUND BUS CONDUCTOR — 'HALO'
IPS	INTERNATIONAL PIPE STANDARD
JB	JUNCTION BOX
KIP	1000 POUNDS (#)
KV	KILOVOLT
KVA	KILOVOLT - AMPERES
KW	KILOWATT
KWH	KILOWATT - HOURS
LA	LIGHTNING ARRESTOR
LL	LIVE LOAD
LP	LIGHTING PANEL
LDP	LIGHTING DISTRIBUTION PANEL
LPG	LIQUEFIED PROPANE GAS
LTV	LET-THROUGH VOLTAGE
LVLD	LOW-VOLTAGE LOAD DISCONNECT
LWC	LIGHT WEIGHT CONCRETE
MAS	MASONRY
MAX	MAXIMUM
M.B.	MACHINE BOLT
мсв	MAIN CIRCUIT BREAKER
мсс	MOTOR CONTROL CENTER
MDP	MAIN DISTRIBUTION PANEL
MECH	MECHANICAL
MGB	MASTER GROUND BUS
MIN	MINIMUM
MISC.	MISCELLANEOUS
MLO	MAIN LUGS ONLY
МО	MASONRY OPENING
MOE	MODULES OF ELASTICITY
MPE	MECHANICAL, PLUMBING, AND ELECTRICAL
MTD	MOUNTED
MTG	MOUNTING
NIU	NETWORK INTERFACE UNIT
N	NEUTRAL
NC	NORMALLY CLOSED
NEC	NATIONAL ELECTRICAL CODE
NF	NON-FUSIBLE
NFPA	NATIONAL FIRE PROTECTION AGENC
NIC	NOT IN CONTRACT
NIST	NATIONAL INSTITUTE OF STANDARD AND TECHNOLOGY
NL	NIGHT LIGHT
NO	NORMALLY OPEN
NSF	NET SQUARE FEET
NTS	NOT TO SCALE
OC or O.C.	ON CENTER
OFCI	OWNER FURNISHED, CONTRACTOR INSTALLED

РВ	PUSHBUTTON STATION (ELEC)				
PC or P.C.	PRECAST				
PCA	PORTLAND CEMENT ASSOCIATION				
PCF	POUNDS PER CUBIC FOOT				
PCI	PRECAST/PRESTRESSED CONCRETE INSTITUTE				
PDP	POWER DISTRIBUTION PANEL				
PH	PHASE				
PL	PLATE				
P.L.	PROPERTY LINE				
PLF	POUNDS PER LINEAR FOOT				
PLY	PLYWOOD				
PP	PANEL POINT				
PSI or P.S.I.	POUNDS PER SQUARE INCH				
PT	PRESSURE TREATED				
РΠ	POST TENSIONING INSTITUTE				
PVI	POINT OF VERTICAL INTERSECTION				
PXFMR	POTENTIAL TRANSFORMER				
RAD	RADIUS				
RBS	RADIO BASE STATION				
RCP	REINFORCED CONCRETE PIPE				
RDP	RECEPTACLE DISTRIBUTION PANEL				
RECEPT.	RECEPTACLE				
RF	RADIO FREQUENCY				
RP	RECEPTACLE PANEL				
(R)	RELOCATED				
RSC	RIGID STEEL CONDUIT				
RX or Rx	RECEIVE				
SCHED	SCHEDULE				
SD	SERVICE DISCONNECT SWITCH				
SDC	SEISMIC DESIGN CATEGORY				
SDI	STEEL DECK INSTITUTE				
SEI	STRUCTURAL ENGINEERING INSTITUTE (ASCE)				
SES	SERVICE ENTRANCE SECTION				
SJI	STEEL JOIST INSTITUTE				
SN	SOLID NEUTRAL				
SOG	SLAB ON GRADE				
SPD	SURGE PROTECTION DEVICE (SEE TVSS)				
SSGB	SHELTER GROUND BUS / SUB-STATION GROUND BUS				
SW	SWITCH				
SWBD	SWITCHBOARD				
SWGR	SWITCHGEAR				
ТВ	TERMINAL BOX				
TIA	TELECOMMUNICATIONS INDUSTRY ASSOCIATION				
ПА-222 -G	CODE FOR TOWER CONSTRUCTION - REVISION "G"				
TGB	TOWER GROUND BUS BAR				

TELECOM	TELECOMMUNICATIONS		
TMS	THE MASONRY SOCIETY		
TNND or T	TINNED		
T.C.	TOWER CENTER		
тос	TOP OF CURBING OR TOP OF CONCRETE		
TOF	TOP OF FOOTING		
TOS	TOP OF STEEL		
TOW	TOP OF WALL		
TP	TAMPER PROOF		
TTB	TELEPHONE TERMINAL BACKBOARD		
TX or Tx	TRANSMIT		
TYP or TYP.	TYPICAL		
XFMR / TR	TRANSFORMER		
TVSS	TRANSIENT VOLTAGE SURGE SUPPRESSOR		
UA or U/A	UNDERGROUND ALARMS (I.E. MONITOR LINE)		
UE or U/E	UNDERGROUND ELECTRICAL		
UG or U/G	UNDERGROUND		
UL or U.L.	UNDERWRITERS LABORATORIES, INC		
U.N.O.	UNLESS NOTED OTHERWISE		
UT or U/T	UNDERGROUND TELCO		
V	VOLTS		
VSWR	VOLTAGE STANDING WAVE RATIO		
w	WIRE		
WP	WEATHERPROOF - NEMA 3R		

ry			VA-CLE		DWN STLE
TOP OF		WHERE QUA	LD S LITY STILL COUN 6390 E. 49 commerce C www.WYC	its Oth Avenue	e 020
BACKBOARD		Engineer \$	Seal:		
SURGE					
IS (I.E.					
RICAL					
RATORIES, INC.	ſ	Revision:	Drawn By:	Ck'd By:	Date: 02/07/17

Issued For:
Construction Drawings

MERCER ISLAND SMALL CELL SOLUTION

MIN 12

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ABBREVIATIONS

Sheet Number:

SYMBOLS

SYMBOL	DESCRIPTION	SYMBOL	DESCRIPTION	<u>LINETYPE</u>	DESCRIPTION	LINETYPE	DESCRIPTION
\triangle 1	REVISION INDICATOR		PROPOSED ANTENNA		CENTER LINE	——ЕОР——	EDGE OF PAVEMENT
1)	KEYED NOTES	$\angle_{\circ} \Delta$	EXISTING ANTENNA		PROPERTY LINE	FIBER	FIBER
1	KEYED NOTES		GROUND ROD		LOT LINE	——— А ———	COAXIAL CABLE
100	ROOM NUMBER		GROUND BUS BAR		EASEMENT LINE	G	GROUNDING ELECTRODE CONDUCTOR
		0	MECHANICAL GROUND	R/W	RIGHT OF WAY		
1 X-1	DETAIL REFERENCE	•	CADWELD	—— GAS —— GAS ——	GAS LINE		
1	ELEVATION REFERENCE		ELECTRIC BOX	——————————————————————————————————————	WATER		
X-1/			TELEPHONE BOX	———Т——	TELEPHONE		
<u> </u>	SECTION REFERENCE	\Rightarrow	LIGHT POLE	——Е—	ELECTRIC		
	GROUT OR PLASTER	E=====================================	UTILITY POLE	SEW	SANITARY SEWER (SEW)		
	(E) BRICK	\prec	POLE DOWN GUY	SD	STORM DRAIN		
	(E) MASONRY	•	FIRE HYDRANT	TV	CABLE TV		
	CONCRETE		TRANSFORMER	STM	STEAM		
	EARTH		TRAFFIC SIGNAL CABINET	OIL	OIL		
	GRAVEL	40	ELECTRIC VAULT	— м — м — м —	MONITOR CONDUIT		
	PLYWOOD	Q.	FIBER VAULT	— P — P — P —	POWER POLE LINE		
	SAND	VAULT	EXISTING VAULT	x	BARBED WIRE FENCE		
	STEEL	(\$)	MANHOLE-SEWER	UNK	UNKNOWN UTILITY		
CUT FILL	SLOPE BANK (1.5:1 MAX. FILL / 2:1 MAX. CUT)	w	MANHOLE-WATER	—— Е/Т ——	U/G JOINT UTILITY TRENCH		
332.0	PROPOSED ELEVATION	9	MANHOLE-STORMDRAIN	→	DRAINAGE DITCH (2' WIDTH)		
332.0	EXISTING CONTOURS	Ē	MANHOLE-ELECTRIC	00000000	GRAVEL BAGS		
		•	MANHOLE-TELCO				
	TRUE NORTH ARROW	\oplus	SURVEY MONUMENT				
			TREE		NOTE: SOME	SYMBOLS AND ABBREVIATIONS SHOWN M	MAY NOT APPLY TO THIS PROJECT.

CROWN CASTLE WA-CLEC, LLC

FIELD SERVICES

6390 E. 49th Avenue Commerce City, CO 80020 www.WYCOFS.com

VP 02/07/17

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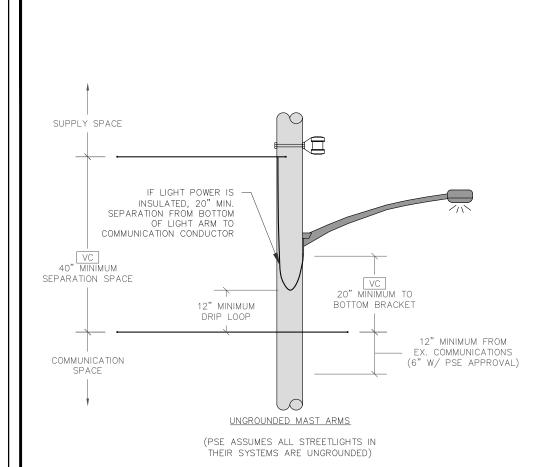
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Sheet Title:

SYMBOLS

Sheet Number:



NESC INSPECTION CRITERIA:

NESC CLEARANCE SHOWN UNDER LOADED CONDITIONS.

*INDICATED RAILROAD MEASUREMENT MAY VARY AS DETERMINED BY THE PERMITTING RAILROAD; CLEARANCE MAY BE AS HIGH AS 36' FT. CHECK WITH RAILROAD FOR CLEARANCE REQUIREMENTS.

CS-CLIMBING SPACE IMPAIRED

STARTING ON THE FIELD SIDE OF THE POLE, A CLEAR SPACE (CLIMBING SPACE) IS REQUIRED THAT ALLOWS A 30"Wx30"Dx40"H
OBJECT TO BE ELEVATED UP THE POLE. THIS SPACE CAN ROTATE A MAXIMUM OF 90 DEGREES EVERY 6" OF POLE HEIGHT. PREFER
A SINGLE CLIMBING SPACE, WITHOUT ROTATION, FROM THE GROUND TO THE TOP OF THE POLE.

PC-POWER CLEARANCE

IMPAIRED CLEARANCE BETWEEN PSE NEUTRAL, TX, QX OR SECONDARY CONDUCTORS AND COMMUNICATION CONDUCTORS ON THE POLE. A MINIMUM OF 40" CLEARANCE IS REQUIRED.

SC-SPAN CLEARANCE

IMPAIRED CLEARANCE BETWEEN PSE CONDUCTORS AND COMMUNICATION CONDUCTORS MIND—SPAN, POLE—TO—POLE AND/OR POLE—TO—SERVICE CONNECTION. PSE NEUTRAL OR SECONDARY WIRE OF TX, QX OR INSULATED OPEN WIRE RUNNING ABOVE AND PARALLEL TO COMMUNICATIONS CONDUCTORS FROM POLE—TO—POLE REQUIRE A MINIMUM 30" OF CLEARANCE. SERVICE DROPS REQUIRE A MINIMUM OF 12" OF CLEARANCE.


VC-VERTICAL CLEARANCE

VERTICAL CONDUCTORS IN COMMUNICATIONS SPACE. MINIMUM 40" OF CLEARANCE REQUIRED BETWEEN THE TOP OF THE CONDUIT RISER AND COMMUNICATIONS CONDUCTORS, THE STREET LIGHT ATTACHMENT BRACKET, AT THE POLE, REQUIRES 20" OF CLEARANCE FROM COMMUNICATIONS CONDUCTORS. STREET LIGHT DRIP LOOPS REQUIRE 12" OF CLEARANCE FROM COMMUNICATION CONDUCTORS, BUT IF IN NON-METALLIC CONDUIT THE REQUIRED CLEARANCE (FROM STREET LIGHT DRIP LOOP) MAY BE REDUCED TO 3".

RC-ROAD CLEARANCE

IMPAIRED CLEARANCE OVER ROADS OR AREAS SUBJECT TO TRUCK TRAFFIC. HEIGHT REQUIREMENTS SHALL BE OVER ANY PORTION OF THE ROAD.

**FOR CLEARANCES OVER STATE HIGHWAYS REVIEW APPLICABLE STATE CODE.

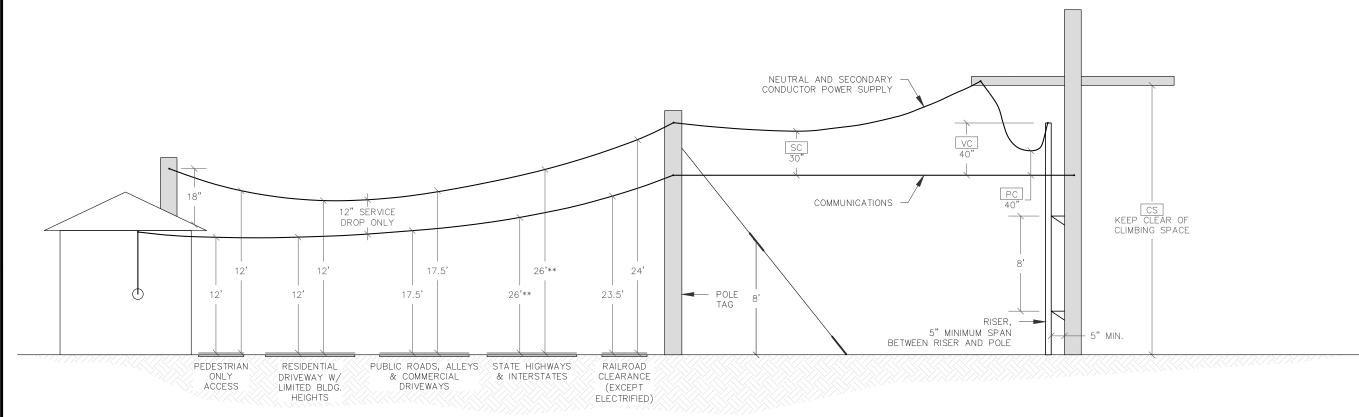



WA-CLEC, LLC



ERE QUALITY STILL COUNTS

6390 E. 49th Avenue Commerce City, CO 80020 www.WYCOFS.com

Engineer Seal:

Revision: Drawn B

WA VP

VP 02/07/17

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Proje

MERCER ISLAND
SMALL CELL SOLUTION

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PSE INSPECTION CRITERIA

■Sheet Number:

T-5

1 PSE INSPECTION CRITERIA

PART 1: SCOPE OF WORK

- 1.1 CODES AND REGULATIONS
 - 1.1.1 COMPLY WITH GOVERNING FEDERAL, STATE & LOCAL LAW, ORDINANCE, CODE RULES & REGULATIONS, SAFETY AND OSHA REGULATIONS/DIRECTIVE. WHERE CONTRACT DOCUMENTS EXCEED THESE REQUIREMENTS. CONTRACT DOCUMENTS SHALL GOVERN. IN NO CASE SHALL WORK BE INSTALLED CONTRARY TO OR BELOW MIN. LEGAL STANDARDS. IT IS CONTRACTOR'S RESPONSIBILITY TO ENSURE ALL STANDARDS ARE MET, AND TO PRODUCE VERIFICATION OF THESE ITEMS UPON
 - 1.1.2 UNLESS INDICATED OTHERWISE, THE LATEST PUBLISHED STANDARDS OF THE FOLLOWING ASSOCIATIONS/ORGANIZATIONS SHALL BE FOLLOWED AND APPLIED WHERE APPLICABLE, AS MIN. REQUIREMENTS.
 - 1.1.2.01 (AHJ) AUTHORITY HAVING JURISDICTION; ALL APPLICABLE AND CURRENT LOCAL JURISDICTIONS AND GOVERNING CODES
 - 1.1.2.02 (AISC) AMERICAN INSTITUTE OF STEEL CONSTRUCTION
 - 1.1.2.03 (ANSI) AMERICAN NATIONAL STANDARDS INSTITUTE

 - 1.1.2.04 (ASTM) AMERICAN SOCIETY FOR TESTING AND MATERIALS
 - 1.1.2.05 (AWS) AMERICAN WELDING SOCIETY
 - 1.1.2.06 (BOCA) BUILDING OFFICIALS & CODE ADMINISTRATORS
 - 1.1.2.07 (ETL) ELECTRICAL TESTING LABORATORY
 - 1.1.2.08 (IBC) INTERNATIONAL BUILDING CODE
 - 1.1.2.09 (ICC) INTERNATIONAL CODE COUNCIL
 - 1.1.2.10 (ICEA) INSULATED CABLE ENGINEERS ASSOCIATION
 - 1.1.2.11 (IEEE) INSTITUTE OF ELECTRICAL AND ELECTRONIC ENGINEERS
 - 1.1.2.12 (NBFU) NATIONAL BOARD OF FIRE UNDERWRITERS
 - 1.1.2.13 (NEC) NATIONAL ELECTRICAL CODE
 - 1.1.2.14 (NEMA) NATIONAL ELECTRICAL MANUFACTURERS ASSOCIATION
 - 1.1.2.15 (NESC) NATIONAL ELECTRIC SAFETY CODE
 - 1.1.2.16 (NFPA) NATIONAL FIRE PROTECTION ASSOCIATION.
 - 1.1.2.17 (IMC) INTERNATIONAL MECHANICAL CODE
 - 1.1.2.18 (UL) UNDERWRITER'S LABORATORIES 1.1.2.19 (SJI) STANDARD JOIST INSTITUTE

1.2 GENERAL

- 1.2.1 CROWN CASTLE, INC. IS HERINAFTER TERMED "CROWN".
- 1.2.2 CONTRACTOR WILL PROVIDE ALL LABOR, MATERIAL, TOOLS, EQUIPMENT,
 TRANSPORTATION AND SERVICES NECESSARY FOR AND INCIDENTAL TO COMPLETION
 OF ALL WORK AS INDICATED ON DRAWINGS, SPECIFICATIONS, SCOPE OF WORK, BILL OF MATERIALS, AND ANY OTHER DOCUMENT ISSUED BY OWNER/CLIENT AND/OR
- 1.2.3 DRAWINGS & SPECIFICATIONS (SPECS.) ARE GENERAL DIRECTIVES FOR THE SCOPE OF WORK. EXACT EQUIPMENT LOCATIONS & ROUTINGS, ETC. SHALL BE GOVERNED BY FIELD CONDITIONS AND CROWN'S INSTRUCTIONS. CONTRACTOR SHALL VERIFY DIMENSIONS & LOCATIONS AND REPORT ANY DISCREPANCIES TO CROWN PRIOR TO COMMENCING RELATED WORK. MINOR ERRORS OR OMISSIONS IN DRAWINGS AND SPECS DO NOT EXCUSE CONTRACTOR FROM COMPLETING PROJECT AND IMPROVEMENTS IN ACCORDANCE WITH THE INTENT OF THESE DRAWINGS AND SPECIFICATIONS.
- 1.3 DRAWING USE AND INTERPRETATION
 - 1.3.1 DRAWINGS ARE DIAGRAMMATIC AND INDICATE GENERAL ARRANGEMENT OF SYSTEMS & EQUIPMENT UNLESS INDICATED OTHERWISE BY DIMENSIONS OR DETAILS.
 - 1.3.2 CONTRACTOR IS RESPONSIBLE FOR SCHEDULING ALL INSPECTIONS AND TESTING REQUIRED FOR EACH PROJECT. 48-HOUR NOTIFICATION TO CROWN IS REQUIRED FOR ALL INSPECTIONS AND TESTING. FIELD COPY OF ALL INSPECTION AND TESTING REPORTS AS WELL AS TRUCK TICKETS MUST BE SUBMITTED TO CROWN WITHIN 24 HOURS OF INSPECTION OR TEST.
 - 1.3.3 CONTRACTOR IS RESPONSIBLE FOR MAINTAINING PRESENT CONDITION OF EXISTING BUILDINGS, LANDSCAPING, FENCING, EQUIPMENT, WALKS, DRIVES, AND ATTACHMENTS. IF ANY DAMAGE SHOULD OCCUR, CONTRACTOR IS RESPONSIBLE TO RESTORE DAMAGE TO A BETTER OR NEW CONDITION.
 - 1.3.4 PERMITS SHALL BE ON-SITE AT ALL TIMES DURING & AFTER CONSTRUCTION.
- - 1.4.1 GENERAL ALL MATERIALS AND EQUIPMENT SHALL BE IN ACCORDANCE WITH CONTRACT DOCUMENTS AND STANDARD PRODUCTS OF THE VARIOUS MANUFACTURERS, WITH ALL MATERIALS AND EQUIPMENT TO BE NEW, CLEAN, UNDAMAGED, AND FREE OF DEFECTS AND CORROSION.
 - 1.4.2 PRODUCT OF AN APPROVED MANUFACTURER IS ACCEPTABLE ONLY WHEN PRODUCT COMPLIES WITH OR IS MODIFIED AS NECESSARY TO COMPLY WITH ALL REQUIREMENTS OF CONTRACT DOCUMENTS.
 - 1.4.3 TESTING EQUIPMENT AND METHODS SHALL BE CODE AND MFGR. COMPLIANT AND ACCEPTED BY CROWN AND OWNER/CLIENT PRIOR TO TESTING.
 - 1.4.4 AFTER TESTING AND/OR INSPECTION BY OWNER/CLIENT OR CROWN, CONTRACTOR SHALL CORRECT DEFICIENCIES AND REPLACE MATERIALS & EQUIPMENT SHOWN TO BE DEFECTIVE OR UNABLE TO PERFORM AT DESIGN OR RATED CAPACITY.
 - 1.4.5 FURNISH AND INSTALL MATERIALS AS REQUIRED FOR COMPLETE SYSTEMS, WHETHER SPECIFICALLY INDICATED OR NOT. SYSTEMS SHALL BE FULLY ASSEMBLED, TESTED, ADJUSTED, & DEMONSTRATED READY FOR OPERATION PRIOR TO OWNER'S ACCEPTANCE.

- 1.4.6 CONTRACTOR IS RESPONSIBLE FOR MAINTAINING A NEAT AND ORDERLY PROJECT SITE. REMOVE AND DISPOSE ALL RUBBISH, WASTE, LITTER, AND FOREIGN SUBSTANCES IN LEGAL MANNER OFF SITE DAILY. EXCESS MATERIAL WILL BE RETURNED TO CROWN AND DELIVERED TO WAREHOUSE FACILITY PER DIRECTION OF CROWN, REMOVE PETROCHEMICAL SPILLS, STAINS, AND OTHER FOREIGN DEPOSITS IN COMPLIANCE WITH OSHA REGULATIONS. RETURN ALL SURFACES TO ORIGINAL
- 1.4.7 TOUCH-UP PAINTING RESTORE & REFINISH TO ORIGINAL CONDITION ALL SURFACES OF EQUIPMENT THAT IS SCRATCHED, MARRED AND/OR DENTED DURING SHIPPING, HANDLING, OR INSTALLATION. REMOVE ALL RUST, AND PRIME/PAINT AS RECOMMENDED BY MANUFACTURER.

1.5 SUBMITTALS & DELIVERABLES

- 1.5.1 CONTRACTOR SHALL PROVIDE THE FOLLOWING DELIVERABLES TO CROWN:
 1.5.1.01 MATERIAL TESTING OF CONCRETE, STRUCTURAL STEEL AND ANY OTHER MATERIAL
 - USED AS REQUIRED BY THE AUTHORITY HAVING JURISDICTION (AHJ).
- 1.5.1.02 INSPECTION SIGN-OFFS, WITH ATTACHED TESTING & INSPECTION REPORTS
- 1.5.1.03 THIRD-PARTY INSPECTION
- 1.5.1.04 GROUNDING SYSTEM TESTING
- 1.5.1.05 ANTENNA SWEEP & PIM TESTING
- 1.5.1.06 CERTIFICATE OF AUTHENTICITY (IF REQUIRED)
- 1.5.1.07 BUILDING AND ELECTRICAL PERMITS
- 1.5.1.08 RELEASE OF WAIVER & LIENS
- 1.5.1.09 ANTENNA PACKETS (EQUIPMENT INFORMATION, PAPERS, ETC.)
- 1.5.1.10 WARRANTIES ON ALL ITEMS INSTALLED AND WORK PERFORMED
- 1.5.1.11 PHOTOGRAPHS OF SITE BEFORE, DURING, AND AFTER CONSTRUCTION. DAILY REPORTS, ALL VENDOR DATA SUBMITTALS AND O&M MANUALS ISSUED WITH
- 1.5.1.12 LIST OF CONTRACTORS; SUPPLIERS; PRODUCT DATA; SHOP DRAWINGS; AND VARIOUS ADMINISTRATIVE SUBMITTALS.
- 1.5.1.13 DAILY FIELD REPORTS, JOB SAFETY ANALYSIS (JSA'S), AND SAFETY MEETING MINUTES
- 1.5.1.14 COMPLETED AND APPROVED FINAL WALK-THRU PUNCH-LIST
- 1.5.1.15 CERTIFICATE OF OCCUPANCY (IF REQUIRED)
- 1.5.1.16 CONTRACTOR SHALL MAINTAIN A FIELD COPY WITH MARKUPS TO GENERATE AS-BUILT DRAWING THROUGHOUT THE PROJECT TO INDICATE INSTALLED LOCATIONS OF EQUIP. & DEVICES, ROUTING OF MAJOR INTERIOR RACEWAY, LOCATION OF CONCEALED & UNDERGROUND EQUIP & RACEWAY, ALL APPROVED MODIFICATIONS TO CONTRACT DOCS, AND DEVIATIONS. THESE DRAWINGS SHALL BE CURRENT & UPDATED DAILY. A NEW, CLEAN SET OF CONTRACT DOCUMENTS WILL BE ISSUED TO CONTRACTOR NEAR COMPLETION TO TRANSFER INFORMATION FROM FIELD DRAWINGS TO NEW AS-BUILT COPY. THIS SHALL BE SUBMITTED WITH DELIVERABLES TO CROWN WITH CLOSE-OUT DOCUMENTS.

1.6 MATERIALS

- 1.6.1 WHERE MORE THAN ONE OF ANY SPECIFIC ITEM IS REQUIRED, ALL SHALL BE OF THE SAME TYPE AND MANUFACTURER.
- 1.6.2 MATERIALS & EQUIPMENT SHALL BE UNDERWRITERS LABORATORIES (UL) LISTED AND LABELED.
- 1.6.3 UNLESS THIS CONTRACT SPECIFIES OTHERWISE, THE CONTRACTOR REPRESENTS THAT THE SUPPLIES AND COMPONENTS, ARE NEW (NOT USED, RECYCLED OR RECONDITIONED) AND ARE NOT OF SUCH AGE OR SO DETERIORATED AS TO IMPAIR THEIR USEFULNESS OR SAFETY. IF THE CONTRACTOR BELIEVES THAT FURNISHING USED OR RECONDITIONED SUPPLIES OR COMPONENTS WILL BE IN THE END-USER'S INTEREST, THE CONTRACTOR SHALL SO NOTIFY CROWN IN WRITING PRIOR TO THE UTILIZATION OF SUCH MATERIALS. THE CONTRACTOR'S NOTICE SHALL INCLUDE THE REASONS FOR THE REQUEST ALONG WITH A PROPOSAL FOR ANY CONSIDERATION TO BE ISSUED BACK TO THE END-USER IF CROWN AND THE END-USER AUTHORIZES THE USE OF SUCH USED OR RECONDITIONED SUPPLIES OR COMPONENTS.

1.7 CONDITION VERIFICATION

1.7.1 THE CONTRACTOR SHALL EXAMINE AREAS & CONDITIONS UNDER WHICH WORK IS TO BE PERFORMED, AND IDENTIFY ANY CONDITIONS DETRIMENTAL TO THE PROPER AND TIMELY COMPLETION OF WORK. DO NOT PROCEED UNTIL UNSATISFACTORY CONDITIONS HAVE BEEN CORRECTED.

1.8 EXECUTION

- 1.8.1 ALL WORK SHALL BE PERFORMED UNDER CONTRACTOR'S DIRECT SUPERVISION, USING SUFFICIENT AND QUALIFIED PERSONNEL AS NECESSARY TO COMPLETE WORK IN ACCORDANCE WITH PROGRESS SCHEDULE. CONTRACTOR SHALL ASSIGN ONE OR MORE COMPETENT SUPERVISORS WHO HAVE AUTHORITY TO ACCEPT & EXECUTE ORDERS & INSTRUCTION, AND WHO SHALL COOPERATE WITH CONTRACTORS, ENGINEERS, AND CROWN IN ALL MATTERS TO RESOLVE CONFLICTS AND AVOID
- 1.8.2 MATERIALS AND EQUIPMENT SHALL BE INSTALLED PER MFGR SPECS, BY MECHANICS EXPERIENCED AND SKILLED IN THEIR TRADE, IN NEAT AND WORKMANLIKE MANNER IN ACCORDANCE WITH STANDARDS OF TRADE, AND SO AS NOT TO ALTER OR VOID WARRANTY OR (UL) LISTING. INSTALLATION OF ALL WORK SHALL BE IN ACCORDANCE WITH INTENT OF CONTRACT DOCS

1.9.1 SEQUENCE, COORDINATE, AND INTEGRATE INSTALLATION OF MATERIALS & EQUIPMENT FOR EFFICIENT FLOW OF WORK IN CONJUNCTION WITH OTHER TRADES. REVIEW DRAWINGS FOR WORK OF ASSOCIATED TRADES AND REPORT AND RESOLVE ANY DISCOVERED DISCREPANCIES PRIOR TO COMMENCING WORK. COOPERATE WITH OTHER CONTRACTORS AND INDIVIDUAL DISCIPLINES FOR PLACEMENT, ANCHORAGE, & ACCOMPLISHMENT OF WORK.

1.10 LAYOUT

- 1.10.1 INSTALL MATERIALS & EQUIPMENT LEVEL, PLUMB, PARALLEL, AND PERPENDICULAR TO OTHER BUILDING SYSTEMS AND COMPONENTS.
- 1.10.2 INSTALL EQUIPMENT, RACEWAYS, AND ETC. TO READILY FACILITATE SERVICING, MAINTENANCE, AND REPAIR OR REPLACEMENT OF COMPONENTS, AND TO MIN. INTERFERENCE WITH OTHER EQUIPMENT AND INSTALLATIONS.
- 1.10.3 PRIOR TO COMMENCING WORK, VERIFY THAT EQUIPMENT WILL ADEQUATELY FIT AND CONFORM TO MANUFACTURED SPECS AND CODE CLEARANCES AND AS INDICATED ON DRAWINGS. IF REARRANGEMENT IS REQUIRED, SUBMIT PLAN AND ELEVATION DRAWINGS OR SKETCHES INDICATING THE PROPOSED REARRANGEMENT FOR THE ENGINEER'S APPROVAL. DO NOT REARRANGE WITHOUT EXPRESSED WRITTEN PERMISSION OF CROWN.
- 1.10.4 PRIOR TO LAYOUT, COORDINATE SPACE FOR ELECTRICAL WIRING, STEAM AND CONDENSATE LINES, SANITARY LINES, DRAIN LINES, FIRE PROTECTION PIPING, AND SHEET METAL DUCT WORK. PROVIDE OFFSETS AS REQUIRED AVOIDING CONFLICTS. RESOLVE CONFLICTS BEFORE COMMENCING INSTALL.

1.11 IDENTIFICATION

- 1.11.1 GENERAL LOCATE NAME PLATE MARKING OR OTHER IDENTIFICATION MEANS ON OUTSIDE OF EQUIPMENT OR BOX FRONT COVERS WHEN ABOVE CEILINGS AND WHEN IN MECHANICAL OR ELECTRICAL EQUIPMENT ROOMS OR OTHER UNFINISHED AREAS, AND ON INSIDE OF FRONT COVER WHEN IN FINISHED ROOMS/ AREAS, USE CONTRACT DOCUMENT DESIGNATIONS FOR IDENTIFICATION UNITESS OTHERWISE NOTED
- 1.11.2 NAMEPLATES/PLACARDS PROVIDE NAME PLATE ENGRAVED WITH EQUIP. DESIGNATION FOR EACH OF THE FOLLOWING ITEMS:

PLACARD LETTER & PLACARD SIZE: 1/2" LETTER; 1" (w) x 2" (l) x1/8" (d) 1.11.2.01 SAFETY/DISCONNECT 1/2" LETTER; 1" (w) x 2" (l) x 1/8" (d) 1.11.2.02 PANEL BOARD 1.11.2.03 OUTLETS (CB# IN PANEL) 1/4" LETTER; 3/4" (w) x 1" (l) x 1/8" (d) 1.11.2.04 TRANSFORMER 1/2" LETTER; 1" (w) x 2" (l) x 1/8" (d) 1.11.2.05 MOTOR STARTER 1/2" LETTER; 1" (w) x 2" (l) x 1/8" (d)

1.11.3 UNDERGROUND WARNING TAPE - DURING TRENCH BACK FILLING FOR EACH UNDERGROUND ELECTRICAL, TELEPHONE, SIGNAL AND COMMUNICATIONS LINE. PROVIDE A CONTINUOUS UNDERGROUND WARNING TAPE AS SPECIFIED. TYPICALLY USE 6" WIDE POLYETHYLENE TAPE PERMANENTLY BRIGHT COLORED WITH CONTINUOUS PRINT INDICATING GENERAL TYPE OF UNDERGROUND LINE BELOW AND "CAUTION". COLORS AS FOLLOWS:

1.11.3.1 RED = ELECTRIC

1.11.3.2 ORANGE = COMMUNICATIONS

- 1.11.4 MARK EACH JUNCTION AND PULL BOX INDICATING SOURCE DESIGNATION AND CIRCUIT NUMBER(S) FOR THE ENCLOSED CONDUCTORS. SEE § 1.11.2.
- 1.11.5 LABEL ALL WIRES AND CABLES AT EVERY POINT OF TERMINATION AND IN ALL PULL BOXES AND JUNCTION BOXES. FOR POWER CIRCUITS, APPLY WIRE TAGS INDICATING APPROPRIATE CIRCUIT OR FEEDER NUMBER TO EACH CONDUCTOR PRESENT IN DISTRIBUTION PANEL AND PANEL BOARD GUTTERS, AND TO EACH CONDUCTOR IN PULL AND JUNCTION BOXES.
- 1.11.6 AT COMPLETION OF PROJECT, ACCURATELY COMPLETE EACH PANEL BOARD CIRCUIT DIRECTORY CARD, IDENTIFYING LOAD SERVED OR CIRCUITS AT EXISTING PANEL BOARD, UPDATE EXISTING (OR PROVIDE NEW) CIRCUIT DIRECTORY CARD TO ACCURATELY REFLECT FINAL CONDITIONS.

1.12 SYSTEM DEMONSTRATION

1.12.1 INSTRUCT CROWN'S REP. IN STARTUP, OPERATION & MAINTENANCE OF ELECTRICAL SYSTEMS & EQUIPMENT AS REQUESTED BY OWNER/CLIENT.



WA-CLEC, LLC

FIELD SERVICES

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02/07/17

Construction Drawings

MERCER ISLAND

MIN 12

SMALL CELL SOLUTION

4030 96TH AVE SE

Mercer Island, WA 98040 Pole ID: 221234-165980

■Coordinates (NAD 84):■ **LATITUDE:** 47.57374171 **LONGITUDE:** -122.2123403

Paper Size & Scales: REPARED AND DESIGNED TO BE PLOTTED O "x17") OR (22"x34") PAPER. ALL SCALES

Sheet Title:

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Sheet Number:

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PART 2: CIVIL / EARTH WORK

- 2.1 EXECUTION
- 2.1.1 IT IS CONTRACTOR'S SOLE RESPONSIBILITY TO CALL LOCAL LOCATING AUTHORITIES

 (OR PRIVATE LOCATING SERVICES) AND PERFORM OTHER STEPS AS REQUIRED TO

 VERIFY LOCATION OF UNDERGROUND UTILITIES OR LINES THAT EXIST WITHIN ENTIRE

 PROJECT AREA. CONTRACTOR SHALL PLACE THESE ITEMS ON AS—BUILT DRAWINGS.
- 2.3 ANTI-EROSION
 - 2.3.1 DITCHES USE RIP—RAP IN AREAS WITH SLOPE GREATER THAN 2:1 IN ENTIRE DITCH, AND FOR 6' IN ALL DIRECTIONS AT CULVERT OPENINGS & WHERE INDICATED ON PLANS.
 - 2.3.1.01 CONTRACTOR SHALL PROTECT ALL AREAS FROM WASHOUTS AND SOIL EROSION. EROSION CONTROL SHALL BE PLACED AT INLET APPROACH TO ALL NEW OR EXISTING CULVERTS.
 - 2.3.1.02 SEED, FERTILIZER, AND STRAW COVER SHALL BE APPLIED TO ALL OTHER DISTURBED AREAS, DITCHES, DRAINAGE, AND SWELLS NOT OTHERWISE RIP—RAPPED. SEED AND FERTILIZER SHALL BE APPLIED TO SURFACE CONDITIONS THAT WILL ENCOURAGE ROOTING. PREPARE SURFACE PROPERLY TO ACCEPT SEEDS. SOW SEEDS IN TWO OPPOSITE DIRECTIONS IN TWICE THE QUANTITY RECOMMENDED BY SEED PRODUCER.
 - 2.3.1.03 CONTRACTOR IS RESPONSIBLE TO ENSURE GROWTH OF SEEDED AND LANDSCAPED AREAS BY WATERING, STRAW, MULCH, NET, AND APPROPRIATE LANDSCAPING METHODS.
 - 2.3.2 AREAS MUST HAVE SUSTAINED GROWTH BY COMPLETION OF PROJECT.

PART 6: ANTENNAS & COAX

- 6.1 PROCESS
 - 6.1.1 CONTRACTOR SHALL INSTALL LINES AND CONDUITS IN NEAT, ORDERLY AND STRAIGHT FASHION PROVIDING ANCHORING AS RECOMMENDED BY MANUFACTURER AND WHERE NECESSARY TO SUPPORT LINES PROPERLY, AND TO RESIST LATERAL WIND & SEISMIC LOADS AS REQUIRED BY IBC AND ASCE.
 - 6.1.2 THE FOLLOWING TABLE WILL BE USED TO DETERMINE MIN. RADIUS OF EACH CABLE:

BENDING RADIUS	DIAM. OF CABLE	CABLE TYPE
5"	3/8"	BBDGE; CAT5E
1"	1/4"	FSJ1
1.25"	1/2"	FSJ4
4.5"	1/2"	LDF4
10"	7/8"	LDF5; AVA5-50FX

6.2 COAXIAL CABLE

- 6.2.1 COAXIAL CABLE SIZE SHALL BE AS SHOWN ON DRAWINGS. SHOULD THERE BE AN INCONSISTENCY BETWEEN THE DRAWINGS AND THE RADIO FREQUENCY DATA SHEET (RFDS), IT SHALL BE BROUGHT TO THE ATTENTION OF THE CROWN REPRESENTATIVE UPON THE DISCOVERY, AND THE INSTALLATION SHALL CEASE UNTIL FURTHER NOTICE. NO WORK SHALL COMMENCE WITHOUT WRITTEN AUTHORIZATION OF ANY CHANGES.
- 6.2.2 COAXIAL CABLE SHALL BE SUPPORTED INSIDE MONOPOLES WITH "KELLEM" GRIP TYPE PRODUCTS.
- 6.2.3 COAXIAL CABLES ON OPEN WAVEGUIDES AND ICE BRIDGES SHALL BE SECURE & SUPPORTED AS INDICATED ON DRAWINGS.
- 6.2.4 COAXIAL CABLES SHALL BE GROUNDED TO GROUND BAR AT ANTENNAS USING GROUNDING KITS AS SPECIFIED ON DRAWINGS.
- 6.2.5 COAXIAL CABLES SHALL BE GROUNDED TO GROUND BAR AT BOTTOM OF TOWER OR MONOPOLE USING KITS SPECIFIED ON DRAWINGS.
- 6.2.6 COAXIAL CABLES SHALL BE GROUNDED TO GROUND BAR AT BULKHEADS USING GROUNDING KITS AS SPECIFIED ON DRAWINGS.
- 6.3 CABLE TRA
 - 6.3.1 PROVIDE COMPLETE CABLE TRAY SYSTEM WITH BENDS, FITTINGS, ACCESSORIES, ETC. AS REQUIRED.
 - 6.3.2 DESCRIPTION——ALUMINUM ALLOY CONSTRUCTION. TYPE——LADDER WITH 18" MAX. SPACING. DEPTH——MIN. 4". WIDTH——AS INDICATED ON DRAWINGS (MIN. 12" HORIZ. RUNS, MIN. 6" VERTICAL RUNS). SUPPORT SPAN——8' MIN. UNLESS OTHERWISE NOTED. LOADING——400 POUNDS/FOOT. RADIUS——36" MIN. (SMALLER RADIUS MAY BE PERMITTED IF APPROVED BY CROWN. COVER——VENTILATED .063 ALUMINUM, PROVIDE WHERE INDICATED.
- 6.3.3 SUSPENDED CABLE TRAY SHALL BE SEISMICALLY BRACED FOR SITES HAVING IBC SEISMIC DESIGN CATEGORY OF C, D, E, OR F.

6.4 TESTING

- 6.4.1 PRIOR TO TESTING, CONTRACTOR WILL PERFORM INSPECTION OF ANTENNA AND COAXIAL SYSTEM AND RECORD FINDINGS ON "ANTENNA INSPECTION FORM." ALL ITEMS SHOULD BE LISTED AS COMPLETE ON FORM PRIOR TO ANTENNA SYSTEM TESTING. CONTRACTOR SHALL VERIFY ALL AZIMUTHS & DOWN TILTS ARE TRUE, AND ENSURE ALL CONNECTORS HAVE BEEN INSTALLED TO MANUFACTURER SPECIFIED TORQUE VALUES (IF APPLICABLE).
- 6.4.2 Contractor shall notify the crown representative a min. of 48 hours prior to antenna systems testing.



Engineering Firm:



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Engineer Seal:

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Construction Drawings

Project:

MERCER ISLAND
SMALL CELL SOLUTION

02/07/17

Node:

MIN 12

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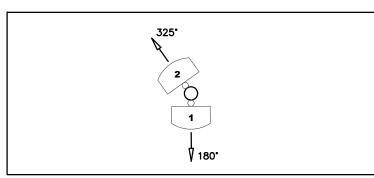
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SIMULATION

C-0

ANTENNA AZIMUTH ORIENTATION

ANT#	MANUF.	MODEL	QTY	<u>AZIMUTH</u>
1	AMPHENOL	HTXCWW631114	1	180°
2	AMPHENOL	HTXCWW631114	1	325°




NOTES

- FIBER & POWER LINES ARE FOR REFERENCE <u>ONLY.</u> REFER TO FIBER DESIGN DRAWINGS FOR ACTUAL PLACEMENT AND DETAILS.
- 2. PULLBOXES ARE SHOWN FOR GENERAL LOCATION <u>ONLY.</u> ACTUAL LOCATION TO BE FIELD LOCATED AND SITUATED TO AVOID ANY IMPENDING SITE FEATURES, SUCH AS ROCKS, TREES, LANDSCAPING, FENCE POSTS, SIGNAGE, ETC. WHEN APPLICABLE.

SITE WORK GENERAL NOTES:

- THE CONTRACTOR SHALL COMPLETE A FULL UTILITY LOCATE SERVICE PRIOR TO THE START OF CONSTRUCTION.
- 2. ALL EXISTING ACTIVE SEWER, WATER, GAS, ELECTRIC, IRRIGATION, AND OTHER UTILITIES WHERE ENCOUNTERED IN THE WORK SHALL BE PROTECTED AT ALL TIMES. WHERE REQUIRED FOR THE PROPER EXECUTION OF THE WORK, UTILITIES SHALL BE RELOCATED AS DIRECTED BY CONTRACTOR. EXTREME CAUTION SHOULD BE USED BY THE CONTRACTOR WHEN EXCAVATING OR DRILLING PIERS AROUND OR NEAR UTILITIES WHEN APPLICABLE.
- 3. CONTRACTOR AND SUB-CONTRACTORS SHALL VERIFY ALL UTILITY SERVICE CONNECTION LOCATIONS AND VERIFY ALL DIMENSIONS AND NOTES PRIOR TO PROCEEDING WITH WORK.
- 4. IF NECESSARY, RUBBISH, STUMPS, DEBRIS, STICKS, STONES AND OTHER REFUSE SHALL BE REMOVED FROM THE SITE AND DISPOSED OF LEGALLY.
- 5. ALL SURFACE REPAIRS SHALL MEET AHJ REQUIREMENTS, IF APPLICABLE.
- 6. THE CONTRACTOR SHALL COORDINATE LOCATION OF POLE AND EQUIPMENT WITH THE SURVEYOR OF RECORD PRIOR TO COMMENCING WORK. ALL NEW POLE INSTALLATIONS SHALL BE 2' MIN. FROM EXISTING SIDEWALKS TO MEET AHJ REQUIREMENTS.
- 7. THE SITE SHALL BE GRADED TO CAUSE SURFACE WATER TO FLOW AWAY FROM THE EQUIPMENT AND TELECOMMUNICATIONS AREAS, IF APPLICABLE.
- 8. NO FILL OR EMBANKMENT MATERIAL SHALL BE PLACED ON FROZEN GROUND, NOR SHALL ANY FROZEN MATERIALS, SNOW OR ICE BE PLACED IN FILL OR EMBANKMENT. THE SUB GRADE SHALL BE COMPACTED AND BROUGHT TO A SMOOTH UNIFORM GRADE PRIOR TO FINISHED SURFACE APPLICATION.
- 9. OPEN EXCAVATIONS, SHALL BE BARRICADED AND SIGNED. NO OPEN EXCAVATIONS WILL BE LEFT ACCESSIBLE TO THE PUBLIC OR LEFT FXPOSED OVER NIGHT
- 10. SUBCONTRACTOR SHALL MINIMIZE DISTURBANCE TO EXISTING SITE DURING CONSTRUCTION. ALL DISTURBED LANDSCAPING SHALL BE REPLACED, RESEED, AND REGROWN TO MATCH THE ORIGINAL CONDITION. EROSION CONTROL MEASURES, IF REQUIRED DURING CONSTRUCTION, SHALL BE IN CONFORMANCE WITH THE LOCAL GUIDELINES FOR EROSION AND SEDIMENT CONTROL.
- 11. ALL WORK IS BEING PERFORMED IN THE RIGHT-OF-WAY. VERIFY ALL R.O.W. LINES, EQUIPMENT LOCATION AND INSTALLATIONS WITH SURVEYED DATA. NO MATERIALS SHALL BE STORED ON PRIVATE PROPERTY.
- 12. LANE CLOSURES OR OBSTRUCTIONS SHALL BE COORDINATED WITH THE AHJ.
- 13. TEMPORARY LIGHTING WILL BE COORDINATED WITH THE AHJ AND PSE PROVIDED WHENEVER EXISTING LIGHTING IS REMOVED OR UNAVAILABLE AS REQUIRED.
- 14. REASONABLE BEST EFFORTS TO DESIGN AND LOCATE ANY IMPROVEMENTS ARE DONE SO IN A WAY TO PRESERVE AND PROTECT LARGE (REGULATED) TREES PER ORDINANCE: MICC 19.10.040.B.2

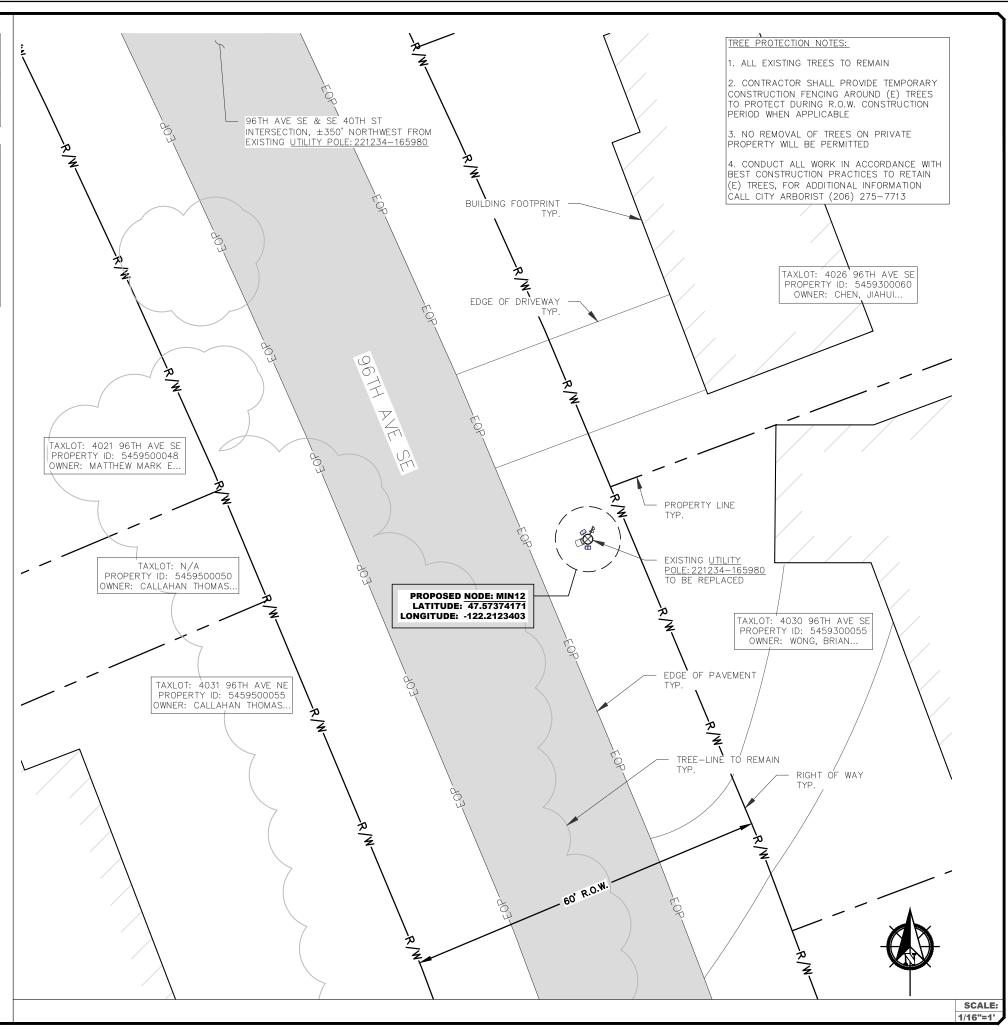



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6390 E. 49th Avenue

Commerce City, CO 80020 www.WYCOFS.com

Revision: Drawn By:

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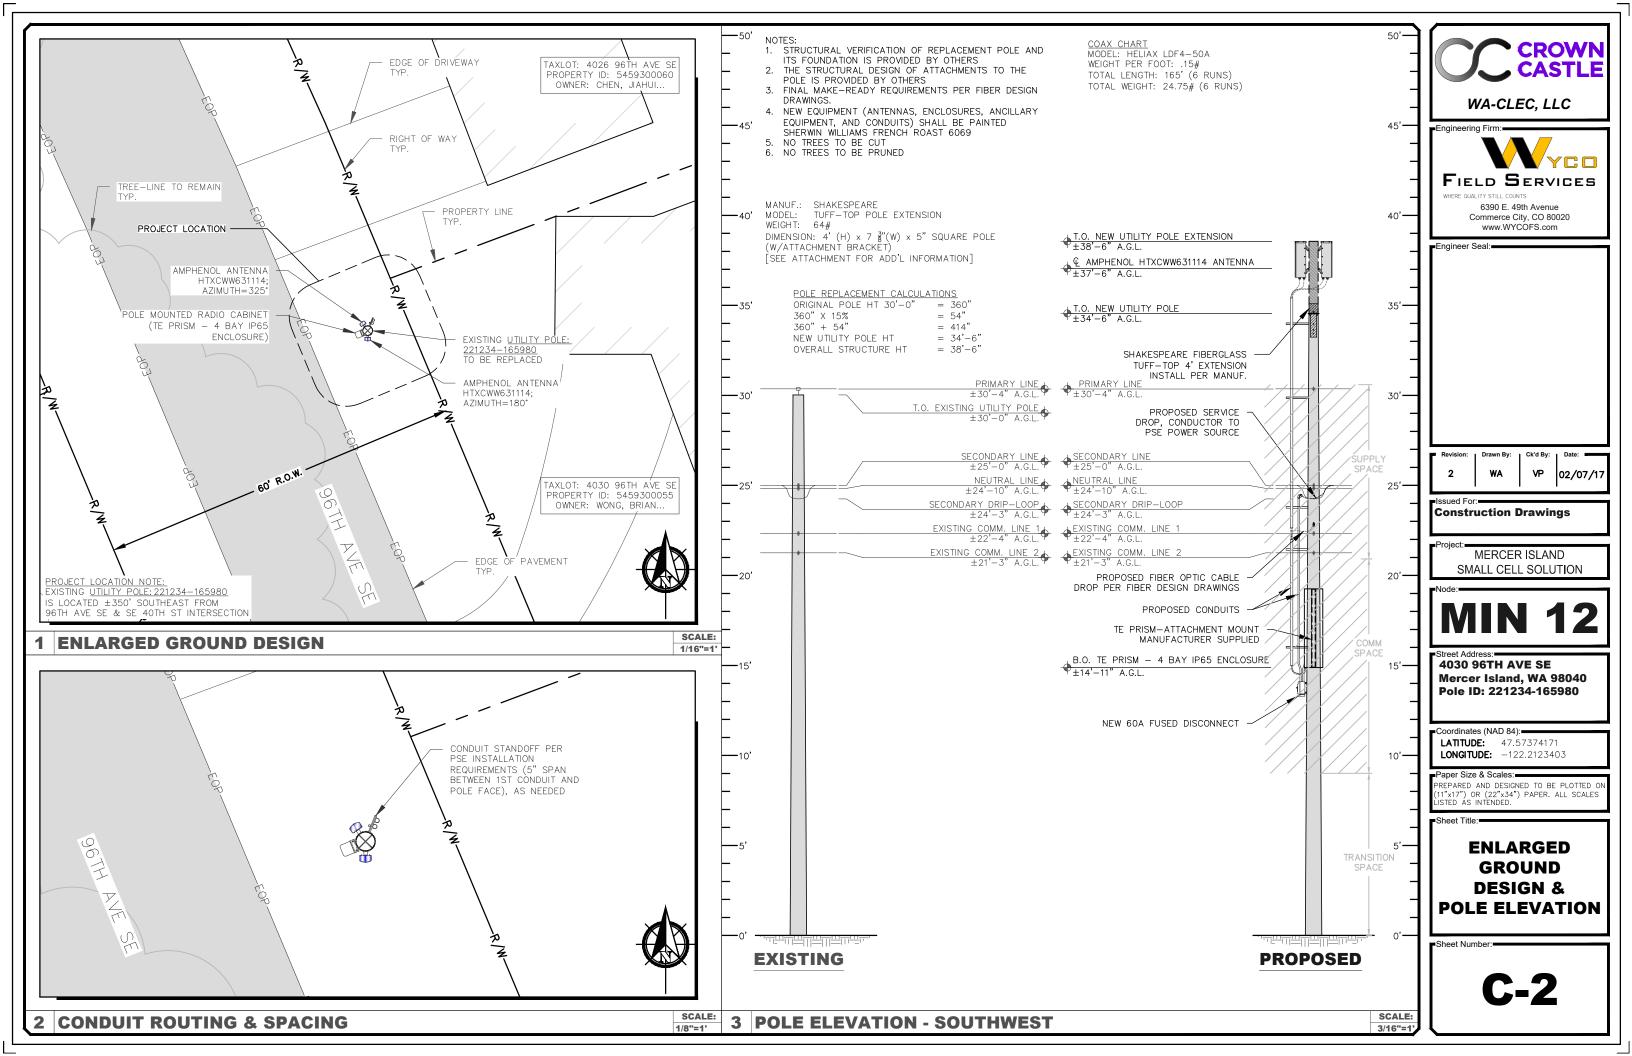
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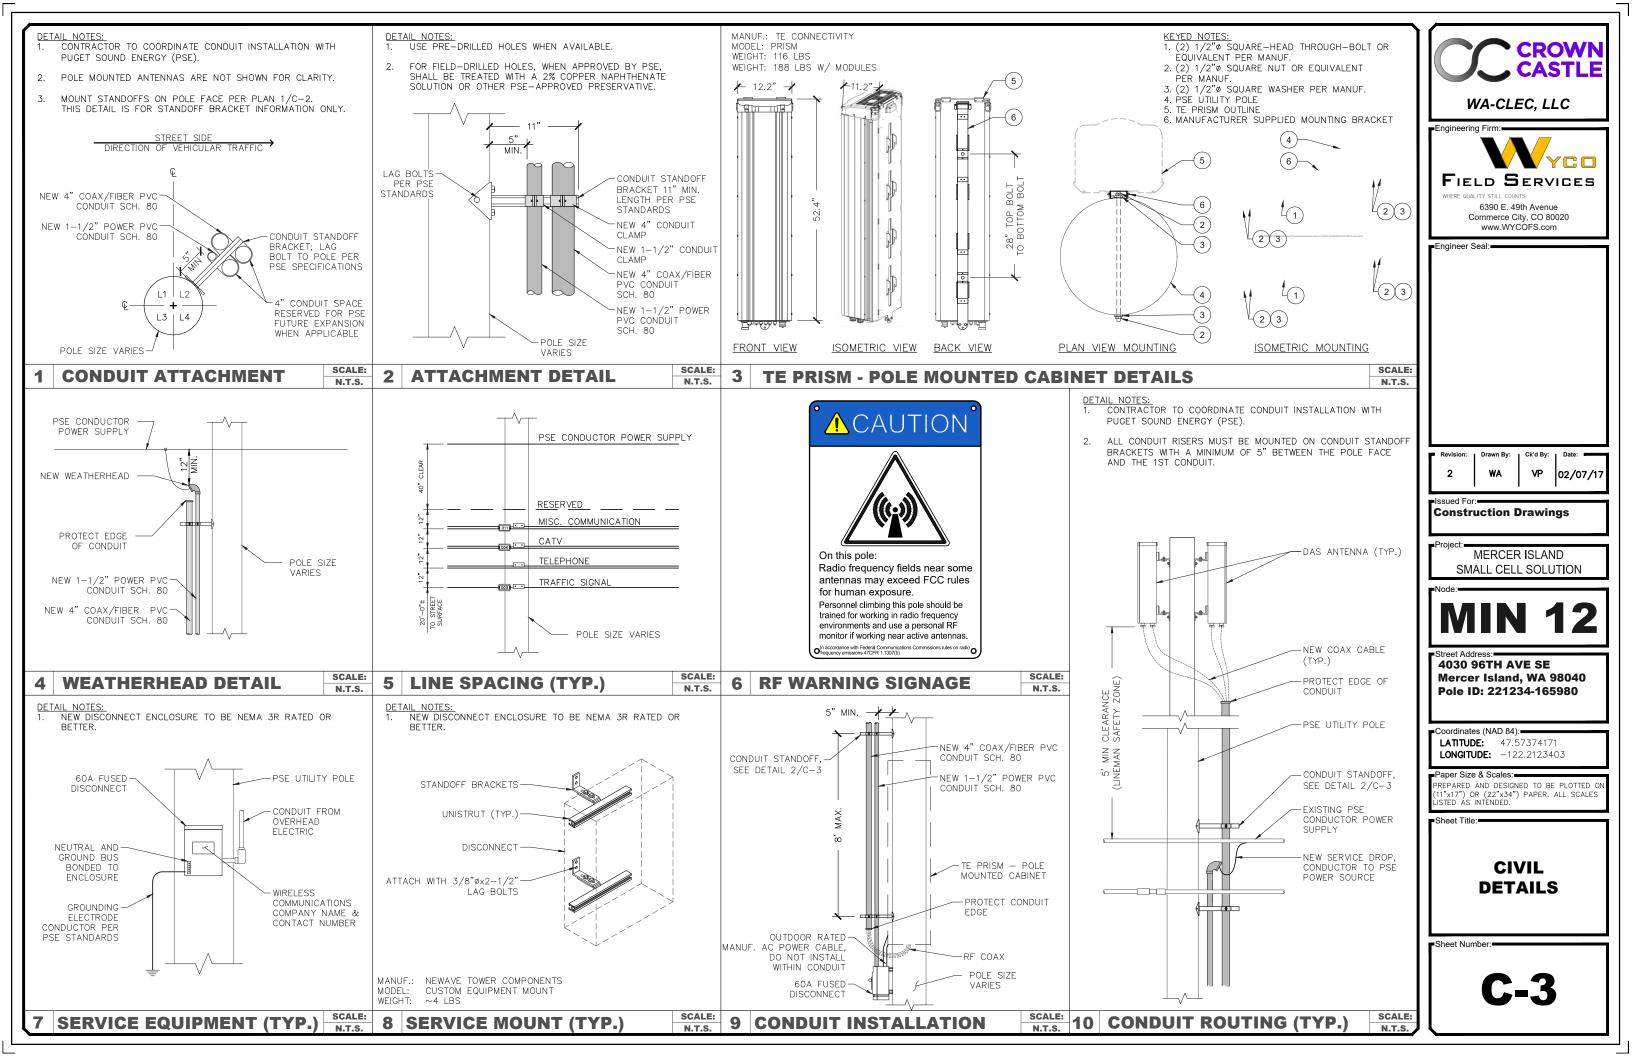
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SITE PLAN

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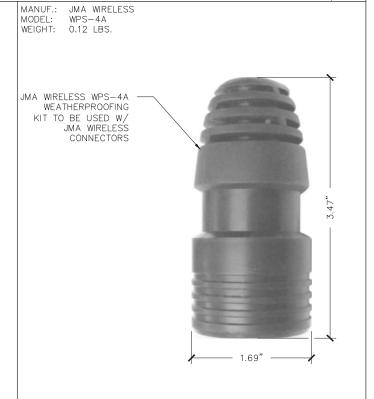





NOTES:

- 1 ACTUAL CABLE LENGTHS SHALL BE DETERMINED PER SITE CONDITION BY SUBCONTRACTOR INSTALLED LENGTHS SHALL BE RECORDED.
- 2. THE DESIGN IS BASED ON RF DATA SHEETS, SIGNED AND APPROVED
- RADIO SIGNAL CABLE AND RACEWAY SHALL COMPLY WITH THE REQUIREMENTS OF THE NATIONAL ELECTRICAL CODE (NEC, NFPA 70),
- ALL SPECIFIED MATERIAL FOR EACH LOCATION (E.G., OUTDOORS, INDOORS-OCCUPIED, INDOORS-UNOCCUPIED, PLENUMS, RISER SHAFTS, ETC.) SHALL BE APPROVED, LISTED, OR LABELED AS REQUIRED BY THE NEC.
- ALL FEEDER LINE AND JUMPER CONNECTORS SHALL BE JMA WIRELESS 7/16 DIN CABLE CONNECTORS THAT MEET IP68 STANDARDS, EXCEPT GPS ANTENNA WITH N-TYPE CONNECTOR WHEN APPLICABLE.
- ANTENNAS, POWER SPLITTERS, AND DIPLEXERS SHALL BE PAINTED WHEN REQUIRED BY THE LANDLORD OR AUTHORITY HAVING JURISDICTION, IN ACCORDANCE WITH MANUFACTURERS' SURFACE PREPARATION AND PAINTING REQUIREMENTS. REMOTE RADIO UNITS AND ACTIVE ANTENNAS SHALL NOT BE PAINTED UNLESS SPECIAL ACCEPTANCE IS OBTAINED FROM CROWN CASTLE.
- CABLE SHIELDS, AND TOWER CONDUITS SHALL BE GROUNDED AT THE TOP OF THE TOWER, WITHIN 10 FEET OF THEIR CONNECTORS, AND AT THE BOTTOM OF THE TOWER ABOUT 6 INCHES BEFORE THEY TURN TOWARD THE FACILITY, VERTICAL RUNS EXCEEDING 200 FEET SHALL ALSO BE GROUNDED AT THE MIDPOINT AND AT INTERVALS OF 100 FEET OR LESS ON TOWERS THAT ARE HIGHER THAN 200 FEET.
- APPROVED GROUNDING KITS, WHICH INCLUDE GROUNDING STRAPS, SHALL BE USED TO GROUND THE COAXIAL CABLE SHIELDS AND CONDUITS. GROUNDING KITS SHALL BE PLACED ONLY ON A STRAIGHT SECTION OF THE COAXIAL CABLE. THE GROUND CONDUCTORS FOR THE KITS AT THE TOP OF THE TOWER, AND IN THE MIDDLE SECTION OF THE TOWER, ARE BONDED DIRECTLY TO TOWER STEEL USING BOLTED, OR APPROVED CLAMP CONNECTIONS. EXOTHERMIC WELDS SHALL BE PERMITTED ON TOWERS ONLY WITH THE EXPRESS APPROVAL OF THE TOWER MANUFACTURER OR THE CONTRACTORS STRUCTURAL ENGINEER.
- ALL RADIO SIGNAL CABLE SHALL BE LABELED AND COLOR CODED PER MARKET REQUIREMENTS.
- 10. ANTENNA FEED LINE SYSTEM SWEEP TESTING SHALL BE PERFORMED AND REPORTED IN ACCORDANCE WITH THE REQUIREMENTS OF PROJECT SPECIFICATIONS. CONTRACTOR WILL NOT ACCEPT A RADIO SIGNAL CABLE INSTALLATION WITH UNSATISFACTORY SWEEP TEST RESULTS.
- 11. PIM TESTS SHALL BE PERFORMED ON NEW AND MOVED OR MODIFIED COAXIAL CABLE INSTALLATIONS. TEST SHALL BE PERFORMED AND REPORTED IN ACCORDANCE WITH PROJECT SPECIFICATIONS.
- 12. DC CONNECTORS AT OUTDOOR BIAS-Ts OR DIPLEXER/TRIPLEXER PORTS SHALL BE WEATHERPROOFED PER MANUFACTURER'S RECOMMENDATIONS.
- 13. CABLES AND CONNECTORS MUST BE PREPARED AND INSTALLED USING THE TOOLS RECOMMENDED BY THE COAXIAL CABLE MANUFACTURER. IT IS THE CONTRACTOR'S RESPONSIBILITY TO ENSURE THAT THE CORRECT TOOLS ARE USED FOR THE SIZE AND TYPE OF COAX AND CONNECTOR, ALL ASPECTS OF INSTALLATION OF ALL COAXIAL CABLE SHALL FOLLOW THE CABLE MANUFACTURER'S RECOMMENDATIONS. INCLUDING THOSE FOR PULLING, MOUNTING AND GROUNDING.
- 14. COAXIAL CABLE SIZES 1/4" AND 1/2" SHALL HAVE A MINIMUM 6 INCH STRAIGHT SECTION WHERE IT IS TERMINATED. CABLE SIZES 5/8" AND LARGER SHALL HAVE A MINIMUM STRAIGHT SECTION OF 12 INCHES.
- 15. PROVIDE A CABLE SUPPORT DIRECTLY BELOW THE GROUND KIT ON A VERTICAL RUN OF COAX CABLE GREATER THAN 1/2 INCH.

SCALE 1 RF NOTES NTS






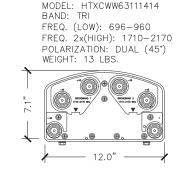


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MANUE: AMPHENOL

ILLUSTRATION BOTTOM VIEW

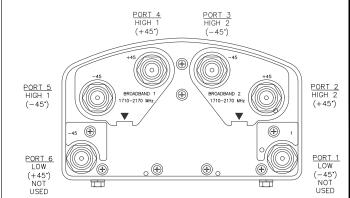

4 PORT DESIGNATIONS

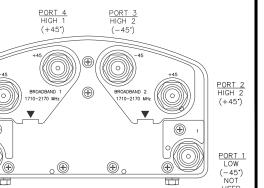

WA-CLEC, LLC www WYCOFS com

SCAL

N.T.S

3 DAS ANTENNA SPECS.

AMPHENOL ANTENNA MOUNT KEYED NOTES:

AMPHENOL HTXCWW63111414 ANTENNA EXISTING OR NEW UTILITY POLE, POLE SIZE VARIES ANGLE BRACKET TYP OF 2 SETS PER ANTENNA,

SEE DETAIL BELOW


GALV. 3/8" THREADED ROD, 3/8" WASHER, LOCKWASER, NUT HEX AT BOTH ENDS (2 PLCS)

RECESS PLATE TO SIT FLUSH ON WOOD POLE GALV. 5/8" BOLT, NUT, WASHER, AND


ANGLE BRACKET PLAN VIEW

ANGLE BRACKET FRONT VIEW

LOCKWASHER TYP OF 4

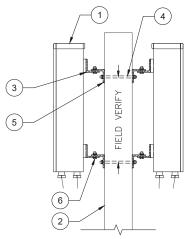

TYPICAL ELEVATION VIEW

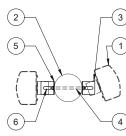

TYPICAL PLAN VIEW

BRACKETS GALVANIZED AFTER FABRICATION

UTILIZE GALVANIZED FASTENERS DURING CONSTRUCTION VERIFY BRACKET DIMENSIONS PRIOR TO FABRICATION

7/16"ø HOLE

ANGLE BRACKET SIDE VIEW

6 ANTENNA MOUNTING (TYP.)

FIELD SERVICES 6390 E. 49th Avenue Commerce City, CO 80020

CROWN

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Construction Drawings

MERCER ISLAND SMALL CELL SOLUTION

4030 96TH AVE SE Mercer Island, WA 98040 Pole ID: 221234-165980

Coordinates (NAD 84): **LATITUDE:** 47.57374171

LONGITUDE: -122.2123403

Paper Size & Scales:

■ PREPARED AND DESIGNED TO BE PLOTTED O "x17") OR (22"x34") PAPER. ALL SCALES

Sheet Title:


RF NOTES & **DETAILS**

SCALE

4 NOT USED

5 WEATHERPROOFING

SCALE:

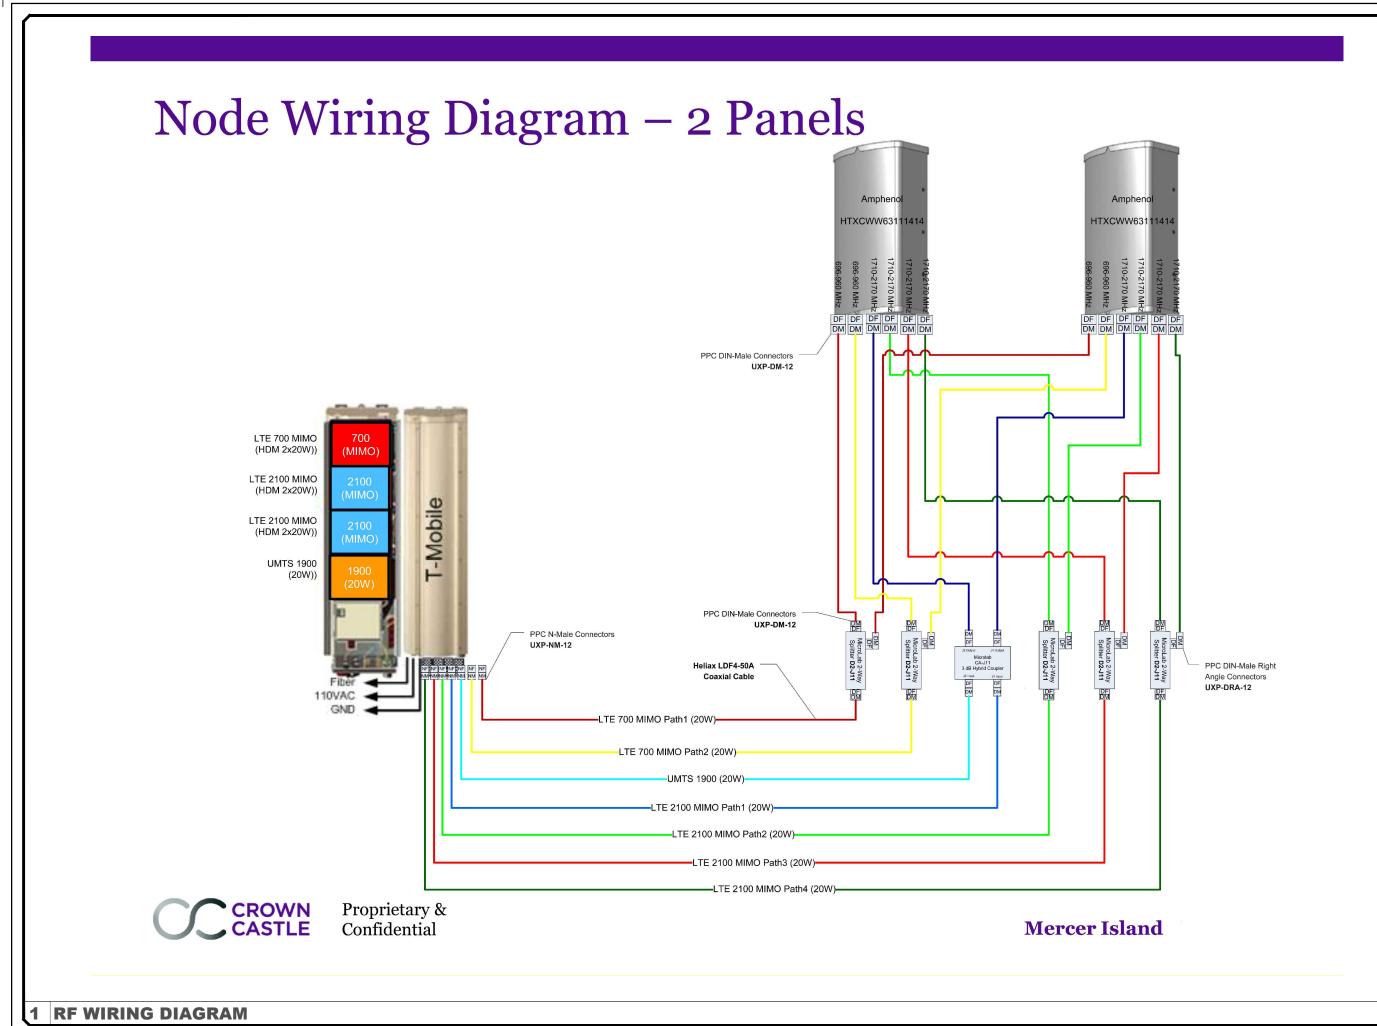



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Issued For:
Construction Drawings

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RF WIRING DIAGRAM

FlexWave Prism

Flexible Outdoor Wireless Coverage and Capacity

REMOTE UNIT ENVIRONMENTAL SPECIFICATIONS

Outside Ambient

Temp Rating: -40° C to +50° C (-40° F to +122° F) -40° C to +70° C (-40° F to +158° F) Storage Temperature: **Humidity:** 10% to 90% non-condensing

Lightning Protection: 20kA IEC 1000-45 8/30 μs Waveform

Remote Unit

Enclosure: IP-65, (Fan IP-55)

Mounting: Wall, Pole, Inside Pole, and Vault

Cooling: Fan (external only)

Optical Connectors: Sealed HMFOC (Multi-fiber connector - 8 fibers) or pass-through

Dimensions:

		Dimensions (H x W x D)		Weight (Chassis Only)	Weight (With RF Modules)	Volume
Circula Barad	25.2"	12.2"	11.2"	65 lbs.	83 lbs.	1.56 cubic ft
Single-Band	64 cm	30.99 cm	28.45 cm	29 kg	38 kg	.044 cubic M
Dual-Band	33.2"	12.2"	11.2"	81 lbs.	117 lbs.	2.10 cubic ft
Dual-Band	84.33 cm	30.99 cm	28.45 cm	37 kg	53 kg	.059 cubic M
Tri-Band	41.2"	12.2"	11.2"	97 lbs.	151 lbs.	2.64 cubic ft
iri-Band	104.65 cm	30.99 cm	28.45 cm	44 kg	68 kg	.075 cubic M
Out of Panel	52.4"	12.2"	11.2"	116 lbs.	188 lbs.	3.40 cubic ft
Quad-Band	133.10 cm	30.99 cm	28.45 cm	53 kg	85 kg	.096 cubic M

Host Unit

5.25" x 19" x 8.43" (13.34 cm x 48.26 cm x 21.41 cm) (3 RUs) Dimensions (H x W x D):

<25 Pounds (<11 kg) Weight:

Remote Unit Power Requirements

100-240 VAC, 50-60 Hz 48 VDC (OPTIONAL) Power Supply: Battery Backup: Yes (optional external UPS)

Host Unit Power Requirements

21 to 60 VDC Power Source:

Element Management

Embedded EMS: Yes

SNMP Based Management: Yes

Note: Unless noted otherwise specifications are typical and subject to change

Fully Populated.



MANUF .: TE CONNECTIVITY MODEL: PRISM WEIGHT: 116 LBS

WEIGHT: 188 LBS W/ MODULES

The Remote Units are available in single, dual, tri and guad band sizes to support

∤12.2"**∤**

up to four bands.

The Remote Unit may be field upgraded and serviced.

www.te.com/WirelessSolutions 1-800-366-3891 10/13 106969AE





696-960 / 1710-2170 / 1710-2170 MHz

HTXCWW63111414Fxy0

Tri Band | FET Panel | XXX-Pol | 65° / 65° / 65° | 11.0 / 14.0 / 14.0 dBi | Fixed Tilt

- Tri band, fixed tilt panel antenna, 6 connectors
- Wide band performance
- Ideal solution for Small Cell applications

Ordering Options

When ordering, replace "x" in the model number with the desired low band electrical downtilt and "y" with the desired high band electrical downtilt (same tilt for both high bands). Tilt options are shown below under Electrical Tilt (°).

Electrical Characteristics	Low Band 6	96-960 MHz		High Band #1 and #2: 1710-2170 MHz			
Frequency Bands (MHz)	696-806 806-960			1710-1880	1850-199	90	1900-2170
Polarization	±4	15°			2x ±45	0	
Horizontal Beamwidth	75°	70°		65°	70°		75°
Vertical Beamwidth	42°	40°		18°	16°		14°
Gain	10.5 dBi	11.0 dB	i	13.5 dBi	14.0 dE	3i	14.0 dBi
Electrical Downtilt (°)	(x)	0, 5			(y) 0, 2, 4	, 6	
Impedance	50	ΩΩ			50Ω		
VSWR	≤ 1	.5:1		≤ 1.5:1			
Front-to-Back Ratio	> 20	0 dB		> 25 dB			
Isolation Between Ports	> 2!	5 dB		> 25 dB			
IM3 (2x20W carrier)	< -15	0 dBc		< -150 dBc			
Input Power	500) W		300 W			
Lightning Protection				Direct Ground	4		
Connector(s)		6 pc	orts /	7/16 -DIN / Female / Bottom			
Mechanical Characteristics							
Dimensions (Height x Width x Diameter)		589 x 305 x	180	mm	23.2 x 12.0	x 7.1	in
Weight without Mounting Brackets			5.9	kg		13	lbs
Survival Wind Speed			241	km/hr		150	mph
Wind Area			0.18 0.11	m² m²	Front: Side:	1.9 1.1	ft² ft²
Wind Loads (160 km/hr or 100 mph)		Front: Side:	219 129	N N	Front: Side:	49 29	lbf lbf



MANUF.: AMPHENOL MODEL: HTXCWW63111414 BAND: TRI BAND FREQ. (LOW): 696-960 FREQ. (HIGH): 1710-2170 POLARIŽATION: ±45° WEIGHT: 13 LBS

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FIELD SERVICES

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Construction Drawings

MERCER ISLAND

SMALL CELL SOLUTION

4030 96TH AVE SE Mercer Island, WA 98040 Pole ID: 221234-165980

Coordinates (NAD 84): **LATITUDE:** 47.57374171


LONGITUDE: -122.2123403 Paper Size & Scales:■

PREPARED AND DESIGNED TO BE PLOTTED O 1"x17") OR (22"x34") PAPER. ALL SCALES STED AS INTENDED.

EQUIPMENT SPECIFICATIONS

Sheet Number:




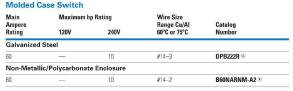


- For replacement pullout head, order part number 96-3258-4.
- To obtain a Service Entrance Rating, the addition of a **DPFG** (ground bar kit) is required.
 To obtain a Service Entrance Rating, the addition of a **GB4NM** (ground bar kit) is required.
 For replacement molded case switch, order part number **BR260NA**.




DPB222R and DPU362R

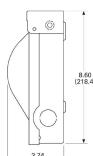


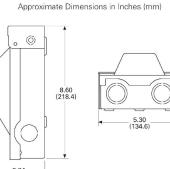


1 TE PRISM ENCLOSURE

3 EATON 60 AMP DISCONNECT

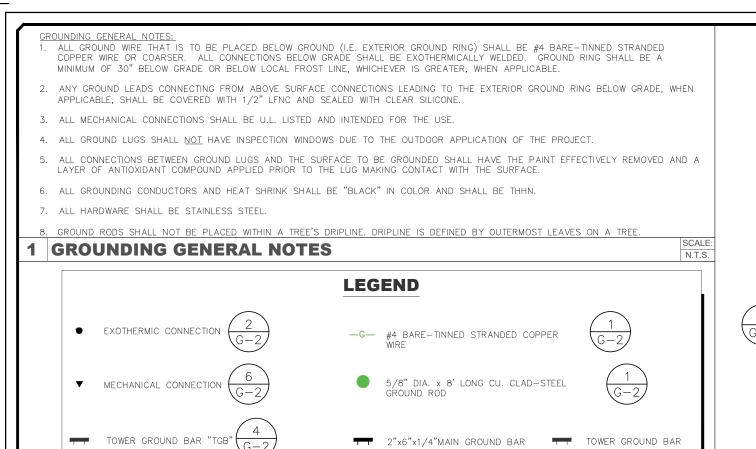

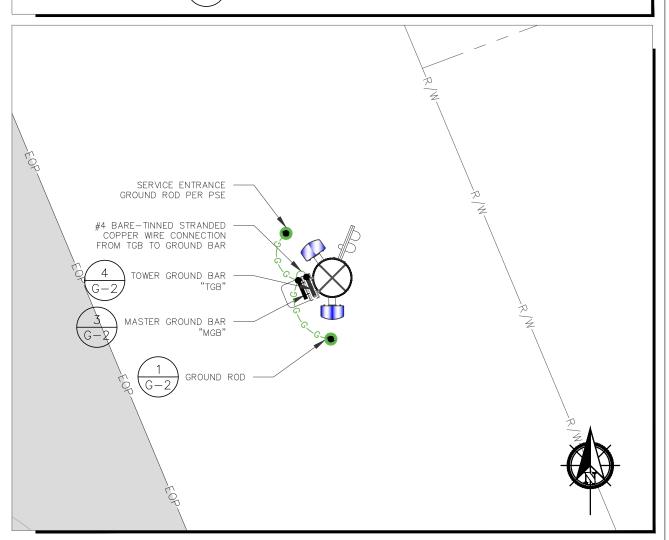

2 SITE GROUNDING PLAN

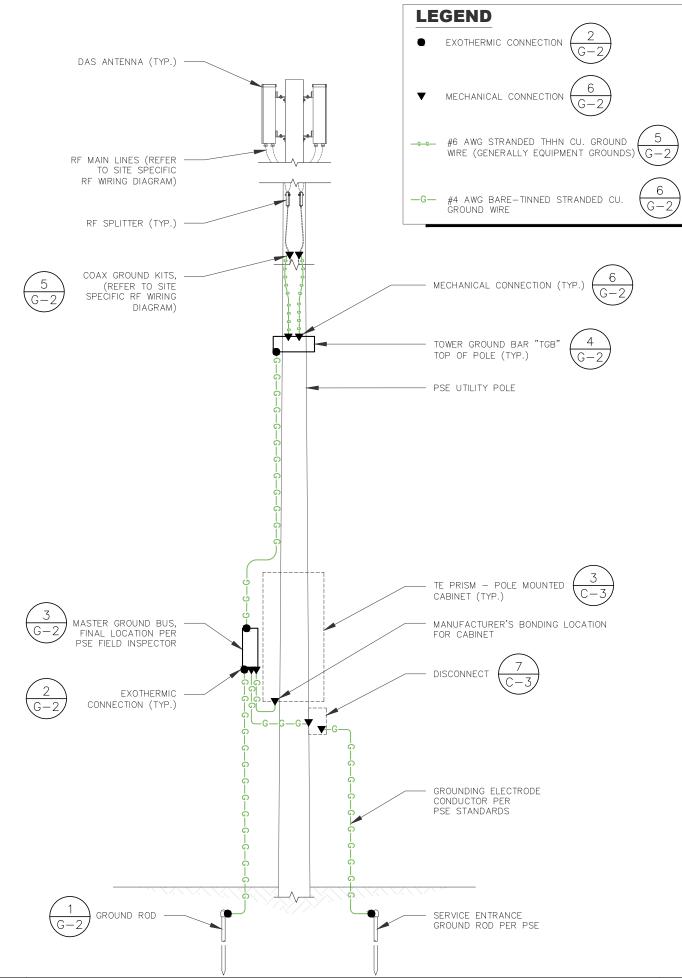



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Construction Drawings

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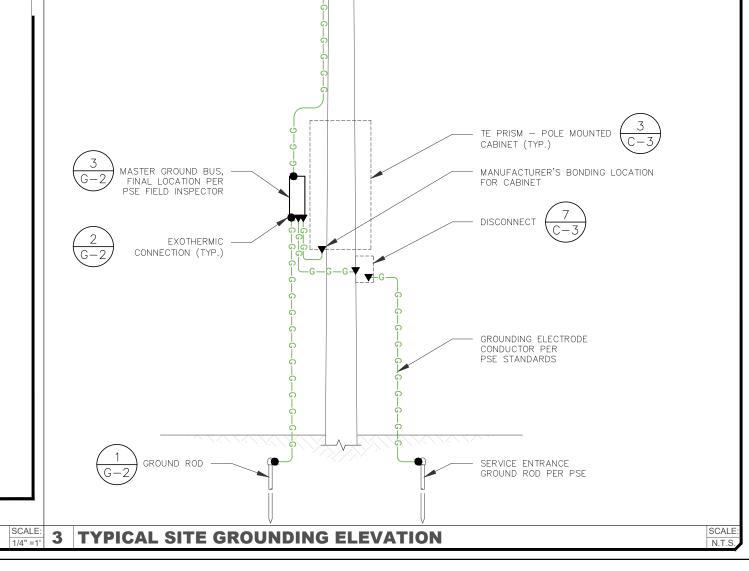
Paper Size & Scales:■


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Sheet Title:


GROUNDING PLAN ELEVATION

G-1




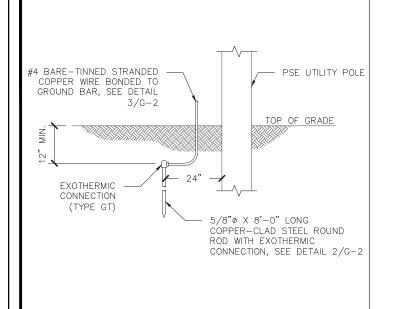


NOTE: ERICO CADWELD "MOLD TYPES" SHOWN HERE ARE EXAMPLES. CONSULT WITH CONSTRUCTION MANAGER FOR SPECIFIC MOLDS TO BE USED FOR THIS PROJECT.

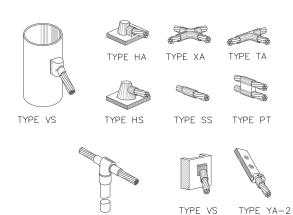

TYPE GT

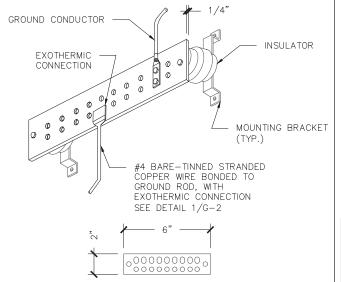

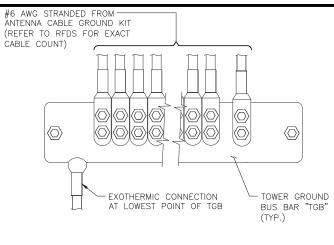

DETAIL NOTES

- ALL GROUND WIRES AND HEAT SHRINK SHALL BE "BLACK" IN COLOR
- ALL GROUND LUGS SHALL BE UL LISTED. GROUND LUGS SHALL NOT HAVE INSPECTION WINDOWS DUE TO OUTDOOR APPLICATION.
- CONTRACTOR TO UTILIZE ANTIOXIDANT ON ALL LUG CONNECTIONS.
- ALL HARDWARE SHALL BE STAINLESS STEEL

GROUND ROD DETAIL EXOTHERMIC WELD TYPES

3/8" FLAT WASHER

BLACK HEAT SHRINK

GROUND CONDUCTOR

2 HOLE LUG

3 MASTER GROUND BUS

4 TOWER GROUND BAR (TGB)

CROWN

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Construction Drawings

MERCER ISLAND SMALL CELL SOLUTION

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GROUNDING DETAILS

😂 ETLW

OR ITLW

SPLIT RING

G-2

ANTENNA CABLE

WEATHERPROOFING KIT EQUIPMENT (NOTE: 3) - 2-HOLE COMPRESSION #6 AWG STRANDED CU WIRE WITH LUG TO GROUND BAR SUNLIGHT RESISTANT GREEN, 600V, INSULATION OR AS PROVIDED WITH

GROUND KIT (NOTES: 1 & 2)

- DO NOT INSTALL CABLE GROUND KIT AT A BEND AND ALWAYS DIRECT GROUND WIRE DOWN TO GROUND BAR.
- GROUNDING KIT SHALL BE TYPE AND PART NUMBER AS SUPPLIED OR RECOMMENDED BY CABLE MANUFACTURER.

5 GROUND KIT TO COAX (TYP)

WEATHERPROOFING SHALL BE (TYPE AND PART NUMBER) AS SUPPLIED OR RECOMMENDED BY CABLE MANUFACTURER AND APPROVED BY CROWN CONSTRUCTION MANAGER.

DETAIL NOTES:

- TWO-HOLE BOLTED TONGUE COMPRESSION CONNECTORS SHALL BE USED EXCEPT WHERE EQUIPMENT MANUFACTURER HAS PROVIDED FOR A SINGLE-BOLT CONNECTION.
- 2. IF A SINGLE HOLE CONNECTOR IS SPECIFIED, AND THE SURFACE IS NOT PREPARED BY CLEANING AND THE APPLICATION OF AN ANTI-OXIDENT COMPOUND, THE SECURING HARDWARE SHALL INCLUDE AN EXTERNAL TOOTH TYPE LOCK WASHER (STAR WASHER) PLACED BETWEEN THE CONNECTOR AND THE SURFACE TO WHICH THE CONNECTOR IS SECURED. THE CONNECTION SHALL ALSO HAVE A SPLIT RING OR EXTERNAL TOOTH LOCK WASHER INSTALLED BETWEEN THE LUG AND THE BOLT HEAD
- A THIN LAYER OF CONDUCTIVE ANTI—OXIDANT COMPOUND SHALL BE APPLIED TO MATING SURFACES; INDOORS AND OUTDOORS. USE STAINLESS STEEL BOLTS, NUTS AND WASHERS FOR ALL CONNECTIONS TO OUTDOOR SURFACES OR OF DISSIMILAR METALS. STAINLESS STEEL OR SILICON BRONZE HARDWARE MAY BE USED INDOORS. ALL HARDWARE ON ANY ONE LUG SHALL BE OF THE SAME MATERIAL
- CORRECTLY SIZED WASHERS SHOULD BE USED WITH A NUT AND BOLT. THE WASHER SHOULD CARRY THE SAME SIZE DESIGNATION AS THE BOLT, SUCH AS 1/4 INCH. USING A WASHER THAT IS TOO LARGE MAY CAUSE THE BOLT OR NUT TO PULL THROUGH THE WASHER OR TO MAKE FULL CONTACT WITH IT'S INTENDED
- 5. WHEN ACCESS IS RESTRICTED TO TIGHTEN THE NUT, THE BOLT HEAD W/FLAT WASHER MAY BE PLACED BEHIND THE GROUND BAR AND THE NUT, LOCK WASHER AND FLAT WASHER ON THE
- - SIDES OF THE GROUND BAR.

_ 3/8" HEX NUT

6 MECHANICAL GROUND (TYP.) SCALE N.T.S


SURFACE TO BE GROUNDED

3/8" FLAT WASHER

3/8" LOCK WASHER

3/8" HEX BOLT

COMPRESSION TERMINAL (LUG) SCHEDULE WIRE SIZE BURNDY MODEL # ITEM(S) TO GROUND #6 AWG YA6C-2TC38 3/8" - 16 NC S 3 BOLT #4 AWG STRANDED YA4C-2TC38 3/8" — 16 NC S 3 BOLT YA3C-2TC38 #2 AWG SOLID 3/8" - 16 NC S 3 BOLT

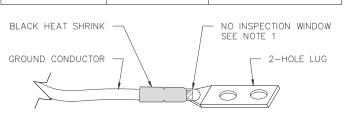


- ALL GROUNDING CONDUCTORS TO BE THHN AND BLACK IN COLOR.
- 2. ALL HEAT SHRINK TO BE BLACK IN COLOR.

7 GROUND LUG SCHEDULE

8 COAX GROUNDING DETAIL

9 GROUND BAR CONNECTION SCHEMATIC

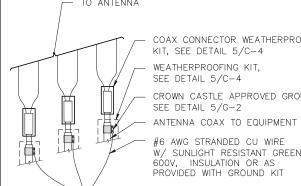

UL LISTED, LONG OR SHORT BARREL


TINNED PLATED COPPER CONNECTOR

WHEN THE NUMBER OF GROUNDING POSITIONS IS LIMITED, IT IS PERMISSIBLE TO PLACE TWO GROUND TERMINALS ON THE SAME POSITIONS


SAME PIECE OF EQUIPMENT

DETAIL NOTES:

1. DO NOT INSTALL CABLE GROUND KIT AT A BEND AND ALWAYS DIRECT GROUND WIRE DOWN TO GROUND BAR. TO ANTENNA COAX CONNECTOR WEATHERPROOFING CROWN CASTLE APPROVED GROUND KIT, W/ SUNLIGHT RESISTANT GREEN, 600V. INSULATION OR AS

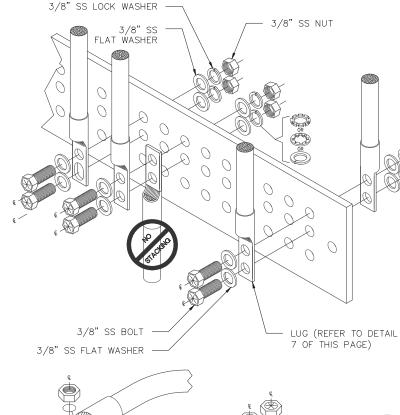

I OR ITLW

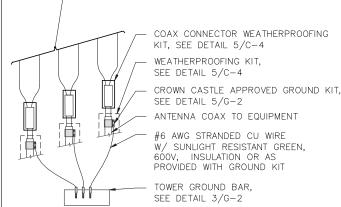

THE GROUND WIRES ARE NOT FROM THE

GENERAL PROJECT NOTES:

- THE CONTRACTOR SHALL PROVIDE ALL LABOR AND MATERIAL NECESSARY FOR A COMPLETE AND FUNCTIONING ELECTRICAL SYSTEM
- MATERIALS AND INSTALLATION SHALL COMPLY WITH CODES, LAWS AND ORDINANCES OF FEDERAL, STATE AND LOCAL GOVERNING BODIES HAVING JURISDICTION.
- ALL MATERIAL, EQUIPMENT, WIRING DEVICES, ETC. SHALL BE NEW, UNLESS SPECIFICALLY INDICATED AS
- 4. PROVIDE COMPLETE METALLIC RACEWAY SYSTEMS AND ENCLOSURES FOR ALL WIRING THROUGHOUT THE EXTENT OF THE REQUIRED SYSTEM.
- 5. FINAL CONNECTIONS MAY BE MADE WITH LIQUID TIGHT FLEXIBLE STEEL CONDUIT, 1/2 INCH MINIMUM.
- ALL CONDUCTORS INSTALLED IN INTERIOR DRY LOCATIONS SHALL BE TYPE THWN OR THHN THERMOPLASTIC 600V INSULATED COPPER CONDUCTORS. NO WIRE SMALLER THAN NO. 12 SHALL BE USED FOR LIGHTING OR POWER WIRING, WIRE NO. 8 AND LARGER SHALL BE STRANDED, ALL CONDUCTORS INSTALLED IN EXTERIOR OR WET LOCATIONS SHALL BE TYPE THWN 600V INSULATED COPPER CONDUCTORS
- ALL CIRCUIT BREAKERS SHALL MATCH THE PANELBOARD MANUFACTURER AND BREAKER TYPES RECOMMENDED BY THE MANUFACTURER. THE CONTRACTOR SHALL PROVIDE NEW TYPE WRITTEN PANEL DIRECTORIES FOR ALL PANELS.
- CONDUITS SHALL BE FASTENED WITH LOCKNUTS AND BUSHINGS AND ALL UNUSED KNOCKOUTS MUST BE SEALED. THERE MUST BE SUFFICIENT ROOM FOR WIRES AND BUSHINGS.
- ALL EQUIPMENT SHALL BE SECURELY AND ADEQUATELY SUPPORTED. PROVIDE UNISTRUT OR SIMILAR FRAMING AS REQUIRED FOR MOUNTING OF SERVICE EQUIPMENT, RACEWAYS, CABLE AND ALL OTHER REQUIRED ELECTRICAL COMPONENTS ON POLE.
- 10. PROVIDE COLD SEQUENCE METERING AS REQUIRED BY UTILITY, INSTALL A FUSED DISCONNECT AHEAD OF THE UTILITY METER WHERE REQUIRED.
- 11. FIELD VERIFY THE UTILITY POINT OF DELIVERY LOCATION AND INSTALL ALL WORK IN ACCORDANCE WITH THE UTILITY CONSTRUCTION STANDARDS. ALL WORK MUST BE PERMITTED, INSPECTED AND APPROVED BY THE LOCAL AUTHORITY HAVING JURISDICTION AND APPROVED BY UTILITY BEFORE METER IS INSTALLED.
- 12. PROVIDE NEW WIRING TO LIGHT FIXTURE MOUNTED ON POLE. PROVIDE LIGHT FIXTURE WITH PHOTOCELL FOR DUSK TO DAWN OPERATION.
- 13. PROVIDE NEW WIRING FOR ALL NEW CIRCUITS, DEVICES, AND ELECTRICAL SYSTEM COMPONENTS AS REQUIRED. PROVIDE CONVENIENCE OUTLETS INSIDE SECURED CABINET. FIELD VERIFY ALL DEVICE AND WIRING REQUIREMENTS WITH OWNER, EQUIPMENT PROVIDERS. AND TELCO/UTILITY PROVIDERS. PROVIDE BREAKER SPACE FOR FUTURE CABINET SUPPLY AND EXHAUST FANS IF NECESSARY.
- 14. NUMBERED CIRCUITS ARE FOR CONVENIENCE OF DESIGN ONLY.

ELECTRICAL LEGEND NOTE: NOT ALL ITEMS APPEAR ON DRAWINGS, SYMBOLS MAY DIFFER FROM EXISTING AND DEMO WORK OR DEVICES REFERENCED FROM DRAWINGS BY OTHERS.

EQUIPMENT DISCONNECT SWITCH

ELECTRICAL PANEL BOARD

TRANSFORMER

EQUIPMENT FUSED DISCONNECT SWITCH


ABBREVIATIONS

GFI GROUND FAULT INTERRUPTING

ELECTRICAL CONTRACTOR

WEATHER PROOF

AHJ AUTHORITY HAVING JURISDICTION

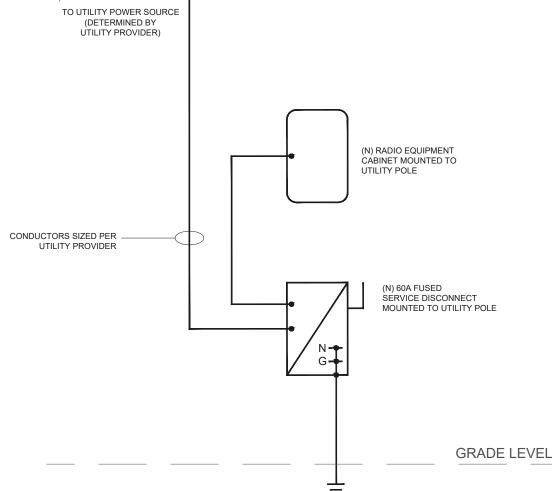

ONE LINE DIAGRAM



PREPARED AND DESIGNED TO BE PLOTTED O (11"x17") OR (22"x34") PAPER. ALL SCALES

CROWN

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VΡ

Construction Drawings

4030 96TH AVE SE

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Mercer Island, WA 98040 Pole ID: 221234-165980

MERCER ISLAND SMALL CELL SOLUTION

02/07/17

ONE LINE DIAGRAM

Sheet Number:

Sheet Title:



- E.C. TO FIELD VERIFY SITE CONDITIONS.
- ALL EQUIPMENT IS NEW UNLESS NOTED.
- ALL EXTERIOR EQUIPMENT TO BE WEATHERPROOF. CONDUCTORS SHALL BE SIZED AND INSTALLED IN ACCORDANCE WITH
- WASHINGTON CITIES ELECTRICAL CODE (CURRENT)



The Exceptionally strong, braggably economical Tuff-Top Pole Extension

Introducing the 5x5 Composite Tuff-Top Pole Extension. Unparalleled strength, unmatched economy.

- Standard, Heavy, and Extra Heavy Duty styles
- Light weight, high load capacities
- Adjustable 6" to 10" for pole diameter (19" to 31" circumference)
- Customer specified lengths up to 20'
- Unexcelled strength
- Composite crossarms available
- Aesthetically pleasing
- Fast, easy installation









Passing the test

Shakespeare Composite Structures Heavy Duty Tuff-Top Pole Extension withstood a 5,000 pound pull in Load Direction A and a 4,000 pound pull in Load Direction B during industry-standard engineering testing.

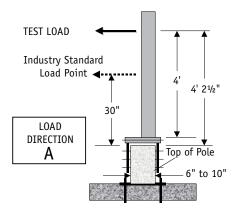


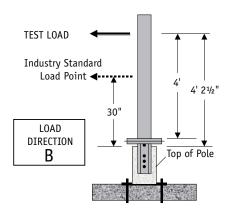




Shakespeare Composite Structures is a Philips Group Brand 19845 U.S. Highway $76 \cdot P0$ Box $733 \cdot$ Newberry, SC 29108 $803.276.5504 \cdot F/803.276.8940$ Toll-free in U.S.A.: 1.800.800.9008

www.skp-cs.com

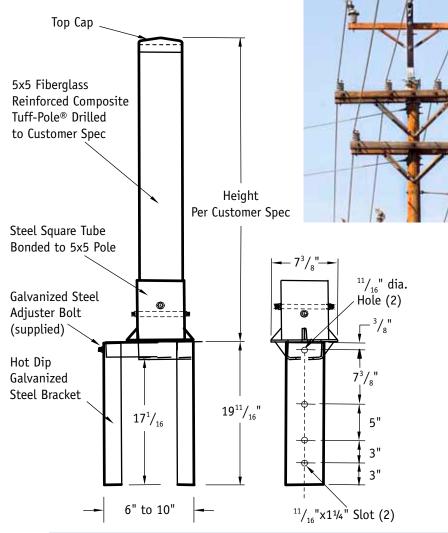

Pole Top Extensions - Heavy Duty

Shakespeare Tuff-Top Pole Extensions

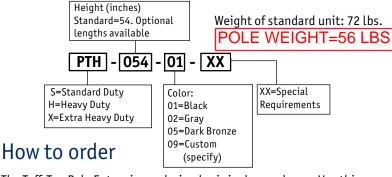

The Tuff-Top Pole Extension ordering logic is shown above. Use this checklist and the diagram above to specify the product you need.

	Standard	Specify
Length	54"	
Color	Black (01)	
Dia. of drilled holes	11/16"	
Hole locations	See diagram	(supply drawing)
Other .		